


PLANTING SCHEDULE					
Label	Quantity	Common Name	Botanical Name	Size / Height	Form
P1	19	Maiden / Red Switch Grass	Panicum virgatum 'Gouldii' / 'Rubrum'	0.6m - 1.2m	Potted
T1	5	Paper Birch	Betula papyrifera	Full Specimen	Balled & Burlapped
T2	3	White Pine	Pinus strobus	Full Specimen	Balled & Burlapped

PART OF THE
WEST 1/2 LOT 18
CONCESSION 3
(GEOGRAPHIC TOWNSHIP OF TAY)
TOWN OF MIDLAND
COUNTY OF SIMCOE

BLOCK 18
51M - 825
PIN 58475-0512 (LT)





No.	DESCRIPTION	DATE
1	FOR PRE-CONSULT	APRIL 28, 2022
2	REVISION - TOWN COMMENTS	JULY 15, 2022
3	FOR CLIENT REVIEW	SEPT 6, 2023
4	FOR PLANNING / WATER BALANCE	NOV 1, 2023
5	FOR PLANNING / WATER BALANCE	NOV 20, 2023
6	FIRST SUBMISSION	DEC 22, 2023
7	FOR PRE-CONSULT	FEB 14, 2024
8	FOR MINOR VARIANCE	APRIL 2, 2024
9	FOR TOWN CONSULT	MAY 28, 2024
10	FOR TOWN CONSULT	JUNE 17, 2024
11	SITE PLAN SUBMISSION	SEPT 25, 2024

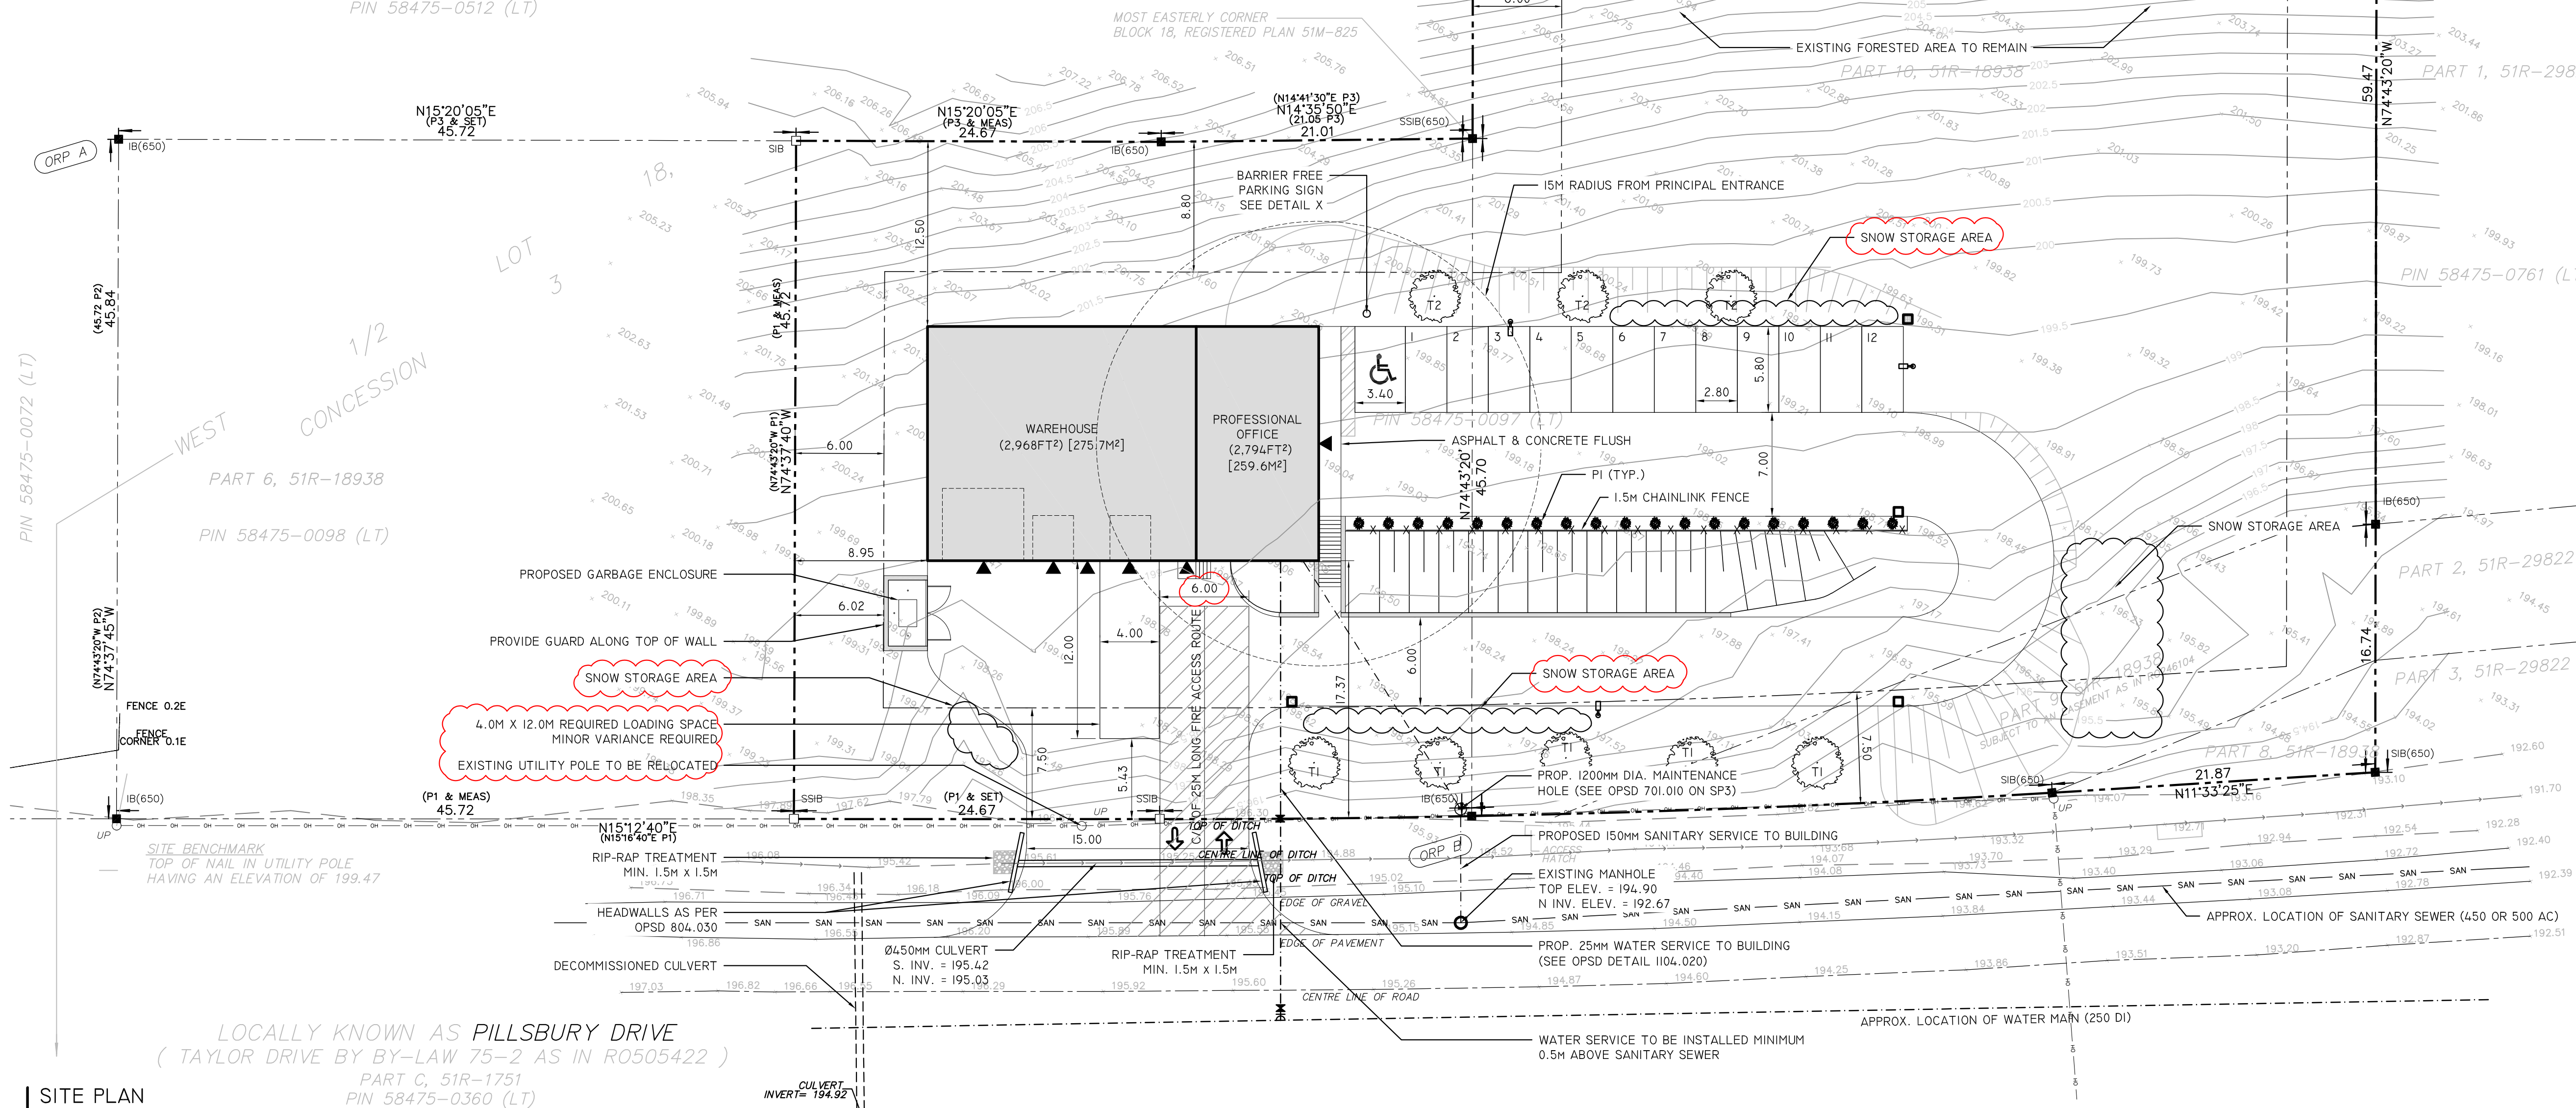

LEGEND:


- WATERMAIN / WATER SERVICE
- S-S- SANITARY SEWER
- S-S-S- SEWER SERVICE
- MAINTENANCE HOLE
- X-X-X- CHAIN LINK FENCE
- LT EXTERIOR WALL SCENCE LIGHTING
- ↑ DIRECTION OF TRAFFIC
- UP UTILITY POLE
- ⊕ VALVE & BOX
- ⊕ CHECK VALVE IN CHAMBER
- ⊕ TAPPING SLEEVE & VALVE BOX
- ⊕ TEE
- ⊕ FIRE HYDRANT C/W VALVE & BOX (AS PER OPSD I105.010)
- ▨ GRASSED AREA
- ▨ PAVED AREA
- ▨ FIRE ROUTE
- ▨ SLOPED LANDSCAPE

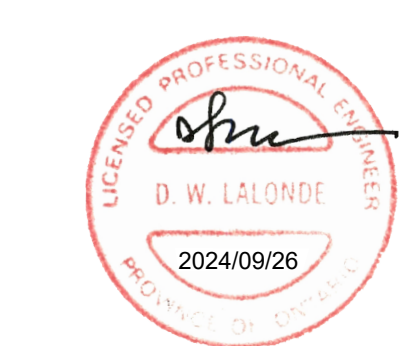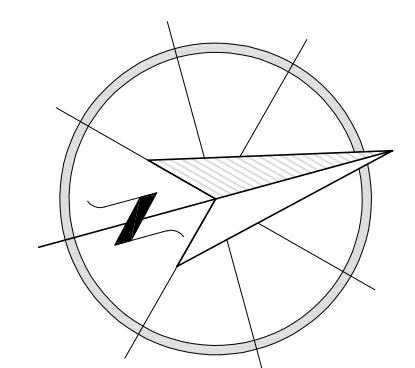

SITE PLAN
SCALE: 1:250

LOCALLY KNOWN AS PILLSBURY DRIVE
(TAYLOR DRIVE BY BY-LAW 75-2 AS IN R0505422)
PART C, 51R-1751
PIN 58475-0360 (LT)

- GENERAL NOTES:**
- CONTRACTOR TO CHECK ALL DIMENSIONS, SPECIFICATIONS, ETC., ON SITE AND IS RESPONSIBLE FOR REPORTING ANY DISCREPANCIES TO OUR OFFICE PRIOR TO CONSTRUCTION. CONTRACTOR TO DETERMINE & CONFIRM THE LOCATION OF EXISTING UTILITIES PRIOR TO CONSTRUCTION.
 - ALL DRAWINGS, SPECIFICATIONS AND RELATED DOCUMENTS ARE THE COPYRIGHT PROPERTY OF QUANTUM ENGINEERING. THEY ARE TO REMAIN THE PROPERTY OF OUR OFFICE AND MUST BE RETURNED UPON REQUEST. THESE DRAWINGS ARE NOT TO BE USED IN ANY OTHER LOCATION WITHOUT THE WRITTEN APPROVAL FROM OUR OFFICE. REPRODUCTIONS OF THESE DOCUMENTS OR DRAWINGS IN WHOLE OR IN PART IS FORBIDDEN WITHOUT WRITTEN PERMISSION FROM OUR OFFICE.
 - ALL CONSTRUCTION & INFRASTRUCTURE SHALL CONFORM TO THE MOST RECENT EDITIONS OF ALL APPLICABLE CODES IN EFFECT AT THE PROJECT LOCATION. ALL WORKS TO BE IN ACCORDANCE WITH THE ONTARIO BUILDING CODE AS WELL AS TOWN OF MIDLAND SPECIFICATIONS.
 - OFFICIAL COPIES MUST BEAR AN ORIGINAL SIGNATURE AND SHOW THE ENGINEERS STAMP IN RED.
 - DO NOT SCALE DRAWINGS.
- GRASSED AREA:**
- ALL DISTURBED AREAS ARE TO BE RESTORED TO ORIGINAL CONDITION AS REQUIRED.
 - GRASSED AREAS TO BE SODDED OVER A MINIMUM 150 MM OF TOPSOIL.
- UTILITIES:**
- BUILDINGS SERVICED MUNICIPAL WATER & SEWER, AND 240V HYDRO. HYDRO SERVICE LOCATION AND INSTALLATION REQUIREMENTS TO BE CONFIRMED WITH LOCAL AUTHORITY (MIDLAND PUC).
 - COMPACTION OF BACKFILL FOR UTILITY TRENCHES SHALL BE 95% SPDD, UNLESS OTHERWISE SPECIFIED BY LOCAL AUTHORITIES.
 - CONTRACTOR RESPONSIBLE FOR LOCATING ALL EXISTING UTILITIES PRIOR TO CONSTRUCTION.
- GARBAGE STORAGE:**
- ALL GARBAGE TO BE STORED IN DUMPSTER LOCATED IN DESIGNATED AREA.
- SNOW STORAGE:**
- ALL SNOW TO BE STORED ON SITE WITHIN DESIGNATED GREEN AREAS.
 - SNOW NOT TO BE PUSHED ONTO OR STORED ON PILLSBURY DRIVE, DESIGNATED PARKING SPACES OR BARRIER FREE SPACES AND PATHS OF TRAVEL.
- BARRIER FREE PATH OF TRAVEL:**
- 0.3 C.B.I.3.1 BARRIER FREE PATH OF TRAVEL SLOPE MAXIMUM 1:20; MINIMUM WIDTH 1.2M (3'-8")
 - MAXIMUM BEVEL 1:2
 - MAXIMUM 12M (Ø") CURB AT LEVEL CHANGES
 - MINIMUM LANDING AT TOP AND BOTTOM OF SLOPED PORTION 1.67M (66") SQUARE
- EXTERIOR LIGHTING:**
- ALL SECURITY LIGHTING TO BE SHIELDED SO THAT LIGHT DOES NOT INFRINGE ON FORESTED AREA, ADJACENT PROPERTIES & WILL BE DARK SKY FRIENDLY.
 - EXTERIOR SCENCE LIGHTING TO BE LITHONIA TWR LED WALL PACK LIGHTING, CATALOG NO. TWRI LED P3 40K MVOLT DBDXT M2, OR APPROVED EQUAL
- DRIVEWAY:**
- PAVED AREA TO BE A MINIMUM OF 75MM HL3A ON A MINIMUM OF 250MM OF GRANULAR 'A' COMPACTED TO 98% SPDD.
 - DRIVEWAY CULVERT TO BE MINIMUM 400MM DIA. ALUMINIZED CORRUGATED STEEL OR DOUBLE WALLED SMOOTH INTERIOR HDPE PIPE.
 - ASPHALT & GRANULAR COURSES SHALL CONFORM TO ALL APPLICABLE ONTARIO PROVINCIAL STANDARDS.
- GRAVEL PAVING:**
- GRAVEL PARKING AREAS TO MEET LEVEL OF PERFORMANCE AS SPECIFIED: ORIGINAL GRADE (95% PROCTOR DENSITY), ISO5MM GRANULAR 'A' (100% PROCTOR DENSITY)
 - GRANULAR COURSES SHALL CONFORM TO ALL APPLICABLE ONTARIO PROVINCIAL STANDARDS.
- PARKING / LOADING:**
- ALL PARKING SPACES MUST CONFORM WITH MOST RECENT EDITIONS OF TOWN OF MIDLAND ZONING BY-LAWS.
 - 1 PARKING SPOT TO BE PROVIDED PER 30 M² OF GFA FOR PROFESSIONAL OFFICE AREA (9 SPOTS MINIMUM).
 - 1 PARKING SPOT TO BE PROVIDED PER 100 M² OF GFA FOR WAREHOUSE/STORAGE AREA (3 SPOTS MINIMUM).
 - MINIMUM 1 BARRIER FREE PARKING SPOT TO BE PROVIDED.
 - ALL LOADING PROVISIONS OUTLINED BY THE MOST RECENT TOWN OF MIDLAND ZONING BY-LAWS MUST BE MET.
- FENCING:**
- FENCING TO BE INSTALLED AS PER ONTARIO PROVINCIAL STANDARDS WITH TOP RAIL, KNUCKLED TOP EDGE FASTENERS, KNUCKLED BOTTOM EDGE AND NO. 9 GAUGE WIRE WESH.
 - CHAIN LINK FENCING TO BE 1.5M HIGH FOR COMMERCIAL/INDUSTRIAL PROPERTIES.
- WATER SERVICING/HYDRANT:**
- MINIMUM COVER FOR WATER SERVICES TO BE 1.8M.
 - WATER SERVICE PIPE SHALL BE 25MM DIA. TYPE "K" COPPER TUBING AND FITTINGS INCLUDING ELECTROCHEMICAL CORROSION PROTECTION WHERE CONNECTED TO DUCTILE IRON WATERMAINS.
 - MAIN STOPS AND SADDLES SHALL BE USED ON WATER SERVICE. MAIN STOP TO BE MUELLER AWWA C800. SADDLE TO BE ROCKWELL 371 & 572.
 - CURB STOP TO BE LOCATED AT PROPERTY LINE AND SHALL BE BALL STYLE WITH COMPRESSION CONNECTION.
 - SERVICES BOXES TO BE MUELLER AWWA C800. ALL SERVICE BOXES ARE TO BE INSTALLED FLUSH WITH THE FINISHED GRADE.
 - A MAXIMUM OF ONE COUPLING IS ACCEPTABLE ON A WATER SERVICE BETWEEN THE CURB STOP AND ENTERING THE BUILDING. COUPLINGS TO BE COPPER COMPRESSION COUPLINGS.
 - WATER METER TO BE SUPPLIED AND INSTALLED BY THE TOWN OF MIDLAND AT CONTRACTOR'S EXPENSE.
 - WATER SERVICE INSTALLATION AND PRESSURE TESTING TO BE COMPLETED IN ACCORDANCE WITH TOWN OF MIDLAND DESIGN STANDARDS.
 - HYDRANT SHALL MEET REQUIREMENTS OF AWWA C502.
 - HYDRANT TO BE CANADA VALVE CENTURY/PREMIERE MODEL, OPENING COUNTERCLOCKWISE, MEETING AWWA C502.
 - GATE VALVES TO BE MUELLER RESILIENT SEAT VALVES, MEETING AWWA C509 C/W BIBBY VALVE BOX TO BE INSTALLED FLUSH WITH THE FINISHED GRADE.
 - CHECK VALVES TO BE MUELLER SWING CHECK VALVES, MEETING AWWA C508 C/W BIBBY VALVE BOX TO BE INSTALLED FLUSH WITH THE FINISHED GRADE.
- SANITARY SERVICING:**
- MINIMUM SLOPE OF SANITARY SERVICE TO BE 2.0%.
 - SANITARY SERVICE SHALL BE LOCATED AT A MINIMUM DEPTH OF 2.0 M AT THE PROPERTY LINE, AND SUFFICIENT DEPTH FOR BASEMENT FLOOR DRAINS AND FROST COVER.
 - FILL BENEATH SANITARY SERVICES IS TO BE COMPACTED TO 98% SPDD.
 - SANITARY SERVICE SHALL BE PVC SDR 28 WITH RUBBER GASKET TYPE JOINTS CONFORMING TO CSA B-182.2.354, AND A MINIMUM DIAMETER OF 150 MM.
 - SANITARY SERVICES ARE TO BE INSTALLED AND TESTED IN ACCORDANCE WITH TOWN OF MIDLAND AND ONTARIO PROVINCIAL STANDARDS.
 - ALL MATERIALS TO BE IN CONFORMANCE WITH ONTARIO PROVINCIAL STANDARD SPECIFICATIONS.
- RESTRAINER COUPLINGS ARE REQUIRED ON ALL WATERMAIN FITTINGS.**
- #12 TWU STANDED COPPER TRACER WIRE TO BE INSTALLED ALONG SPRINGLINE OF ALL NON-METALLIC WATERMAIN. TRACER WIRE TO BE WRAPPED AROUND EACH JOINT AND BROUGHT TO THE SURFACE AT EACH HYDRANT AND CONNECTED TO FLANGE BOLT. CONTINUOUS LENGTH OF WIRE MUST BE USED. INSTALLATION AND CONTINUITY TESTING TO BE COMPLETED AS PER TOWN OF MIDLAND STANDARDS.**
- ZONING INFORMATION:**
- CURRENT ZONING DESIGNATION: INDUSTRIAL ZONE - MI
PROPOSED CHANGE TO ZONING: NO
CURRENT BUILDING CLASSIFICATION: N/A
PROPOSED BUILDING(S) CLASSIFICATION: F3 (LOW HAZARD INDUSTRIAL OCCUPANCY)
GROSS FLOOR AREA: PROPOSED 5,762 SQ. FT (535.3 M²)
PROFESSIONAL OFFICE = 259.6 M²
WAREHOUSE = 275.7 M²
- ZONING REQUIREMENTS:**
- (AS PER TOWN OF MIDLAND INDUSTRIAL ZONE - MI)
- MINIMUM LOT AREA: 4000M² (ACTUAL: 6745.8 M² APPROX.)
MINIMUM LOT FRONTAGE: 30 M
MAXIMUM LOT COVERAGE: 60% (PROPOSED: 6.1%)
MINIMUM YARD SETBACKS:
(A) FRONT: 7.5M
(B) REAR: 8.8M
(C) INTERIOR SIDE: 6.0M
(D) EXTERIOR SIDE: 7.5M
MAX. BUILDING HEIGHT: 11.0M
- SURFACE AREAS:**
- TOTAL SITE AREA: 6745.8 M²
BUILDING FOUNDATION FOOTPRINT: 413.8 M²
BUILDING ROOF SURFACE AREA: 413.8 M²
TOTAL PAVED AREA: 1202.4 M²
TOTAL GRASSED AREA: 898 M²
TOTAL FORESTED AREA (EXISTING TO REMAIN): 4231.6 M²
- NOTE: DISTANCES ON THIS PLAN ARE METRIC AND CAN BE CONVERTED TO IMPERIAL BY MULTIPLYING BY 3.28

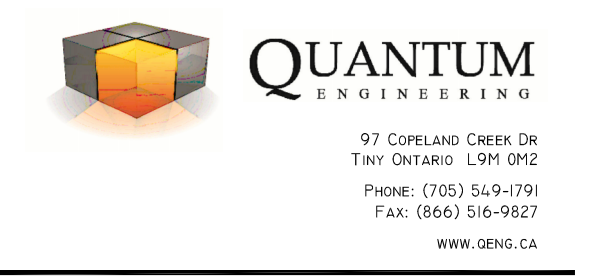

PROJECT: **NEW COMMERCIAL FACILITY**

LOCATION: 120 PILLSBURY DR. MIDLAND, ONTARIO

FOR: SCHULTZ - VANT SPYKER

DRAWING: **SITE PLAN**

DATE	PROJECT NO.	PAGE ID
AUG. 2023		

DRAWN BY: K.J.L. 6506 CI


SCALE: SEE PLOT




No.	DESCRIPTION	DATE
1		
2		
3		
4		
5		
6	FIRST SUBMISSION	DEC 22, 2023
7	FOR PRE-CONSULT	FEB 14, 2024
II	SITE PLAN SUBMISSION	SEPT 25, 2024

BLOCK 18
51M - 825
PIN 58475-0512 (LT)



PART OF THE
WEST 1/2 LOT 18
CONCESSION 3
(GEOGRAPHIC TOWNSHIP OF TAY)
TOWN OF MIDLAND
COUNTY OF SIMCOE

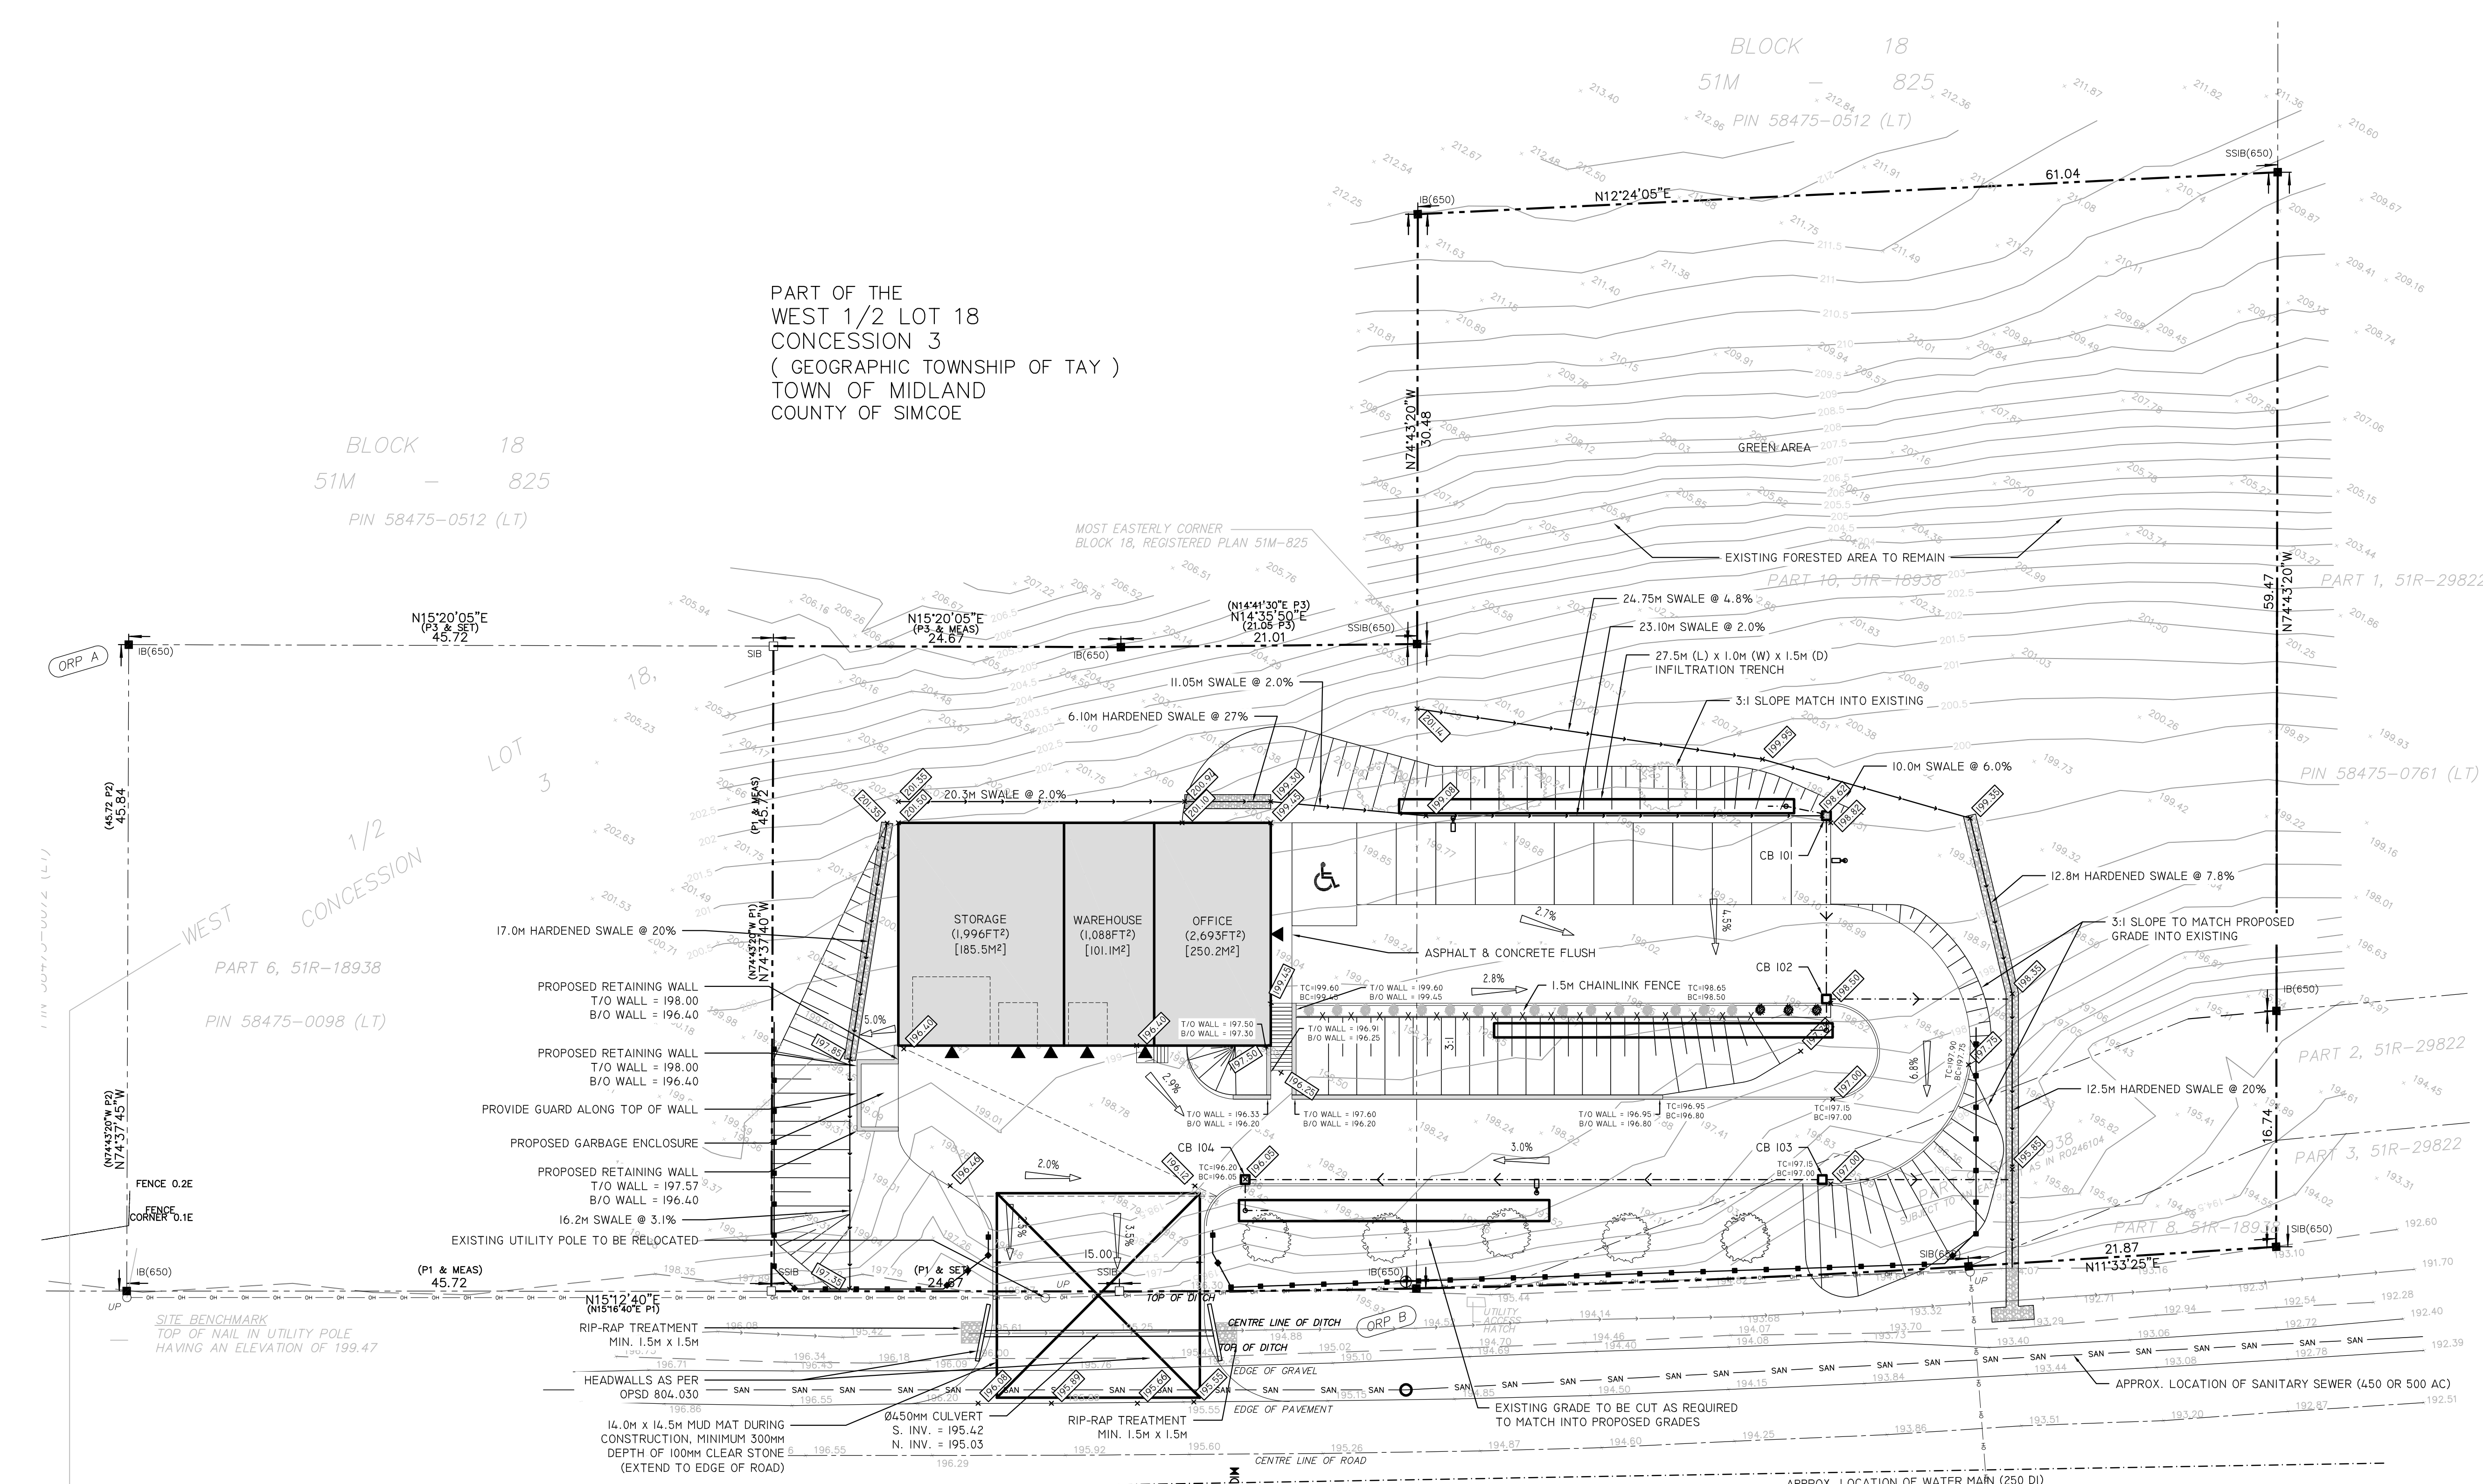

LOCALLY KNOWN AS PILLSBURY DRIVE
(TAYLOR DRIVE BY-BY-LAW 75-2 AS IN R0505422)
PART C, 51R-1751
PIN 58475-0360 (LT)

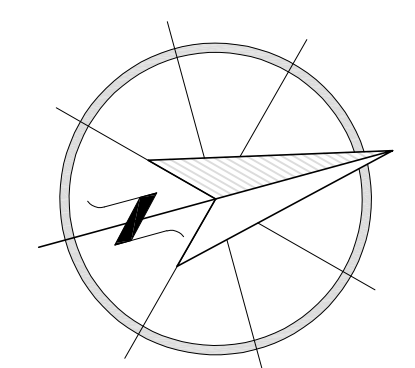

- GENERAL NOTES:**
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 - OFFICIAL COPIES MUST BEAR AN ORIGINAL SIGNATURE AND SHOW THE ENGINEERS STAMP IN RED.
 - DO NOT SCALE DRAWINGS.
- GRADING / DRAINAGE NOTES:**
- "SEDIMENT AND EROSION CONTROL MEASURES SHALL BE IMPLEMENTED TO PREVENT MIGRATION OF SILT AND SEDIMENT FROM THE SUBJECT LOT TO ANY ADJACENT LOT, INCLUDING MUNICIPAL OR PUBLIC RIGHT-OF-WAY. SPECIAL CARE SHALL BE TAKEN TO ENSURE THAT SILT AND SEDIMENT LADEN SURFACE WATER DOES NOT ENTER ANY WATERCOURSES OR ENVIRONMENTALLY SENSITIVE AREAS, EITHER OVERLAND OR THROUGH THE STORM DRAINAGE SYSTEM. THE OWNER/BUILDER/APPLICANT SHALL COMPLY WITH ALL DIRECTIVES ISSUED BY ANY APPLICABLE ENVIRONMENTAL AGENCY."
 - "INTERIM GRADING MEASURES MAY BE REQUIRED DURING BUILDING CONSTRUCTION TO ENSURE THAT DRAINAGE DOES NOT ADVERSELY AFFECT THE NEIGHBORING PROPERTIES. ROUGH GRADING OF THE PROPERTY SHALL BE COMPLETED SUCH THAT DRAINAGE IS CONTAINED ON SITE OR CONTROLLED TO A POSITIVE OUTLET."
 - "ALL DOWNSPOUTS, SUMP PUMP AND OTHER DRAINAGE DISCHARGE POINTS SHALL DISCHARGE ON TO A SPLASH PAD OR APPROVED EQUIVALENT."
 - "THE OWNER/BUILDER/APPLICANT IS RESPONSIBLE FOR OBTAINING UTILITY AND SERVICING LOCATES PRIOR TO ANY WORKS."
 - "THE LOT GRADING/DRAINAGE PLAN HAS BEEN DESIGNED/COMPLETED SUCH THAT MUNICIPAL, COUNTY AND PROVINCIAL LANDS ADJACENT TO OR IN THE VICINITY OF THIS LOT ARE NOT AFFECTED."
 - "A COPY OF THE "ACCEPTED FOR CONSTRUCTION" LOT GRADING/DRAINAGE PLAN IS TO BE ON SITE FOR REFERENCE AT ALL TIMES DURING CONSTRUCTION."
 - "THIS LOT GRADING/DRAINAGE PLAN HAS BEEN DESIGNED/COMPLETED TO PREVENT DRAINAGE TOWARDS THE FOUNDATION AFTER SETTLING."
 - "THIS LOT GRADING/DRAINAGE PLAN HAS BEEN DESIGNED/COMPLETED SUCH THAT SURFACE DRAINAGE (WATER) FROM THE LOT WILL NOT ADVERSELY AFFECT NEIGHBORING PROPERTIES."

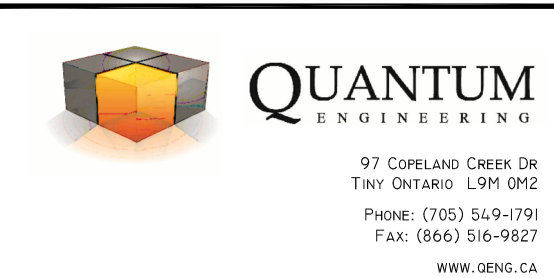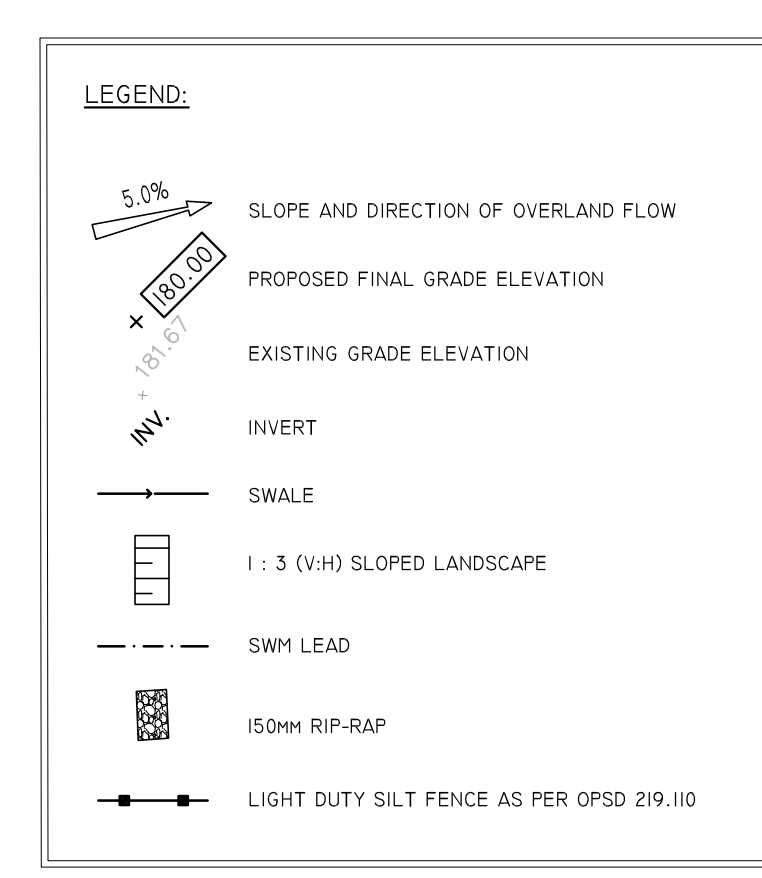

PROJECT: NEW COMMERCIAL FACILITY
LOCATION: 120 PILLSBURY DR. MIDLAND, ONTARIO
FOR: SCHULTZ - VANT SPYKER
DRAWING: LOT GRADING PLAN


DATE	PROJECT NO.	PAGE ID
DEC. 2023	5606	C2

DRAWN BY: D.L.W.
SCALE: SEE PLOT


LOT GRADING PLAN
SCALE: 1:250




No.	DESCRIPTION	DATE
1		
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6	FIRST SUBMISSION	DEC 22, 2023
7	FOR PRE-CONSULT	FEB 14, 2024
II	SITE PLAN SUBMISSION	SEPT 25, 2024

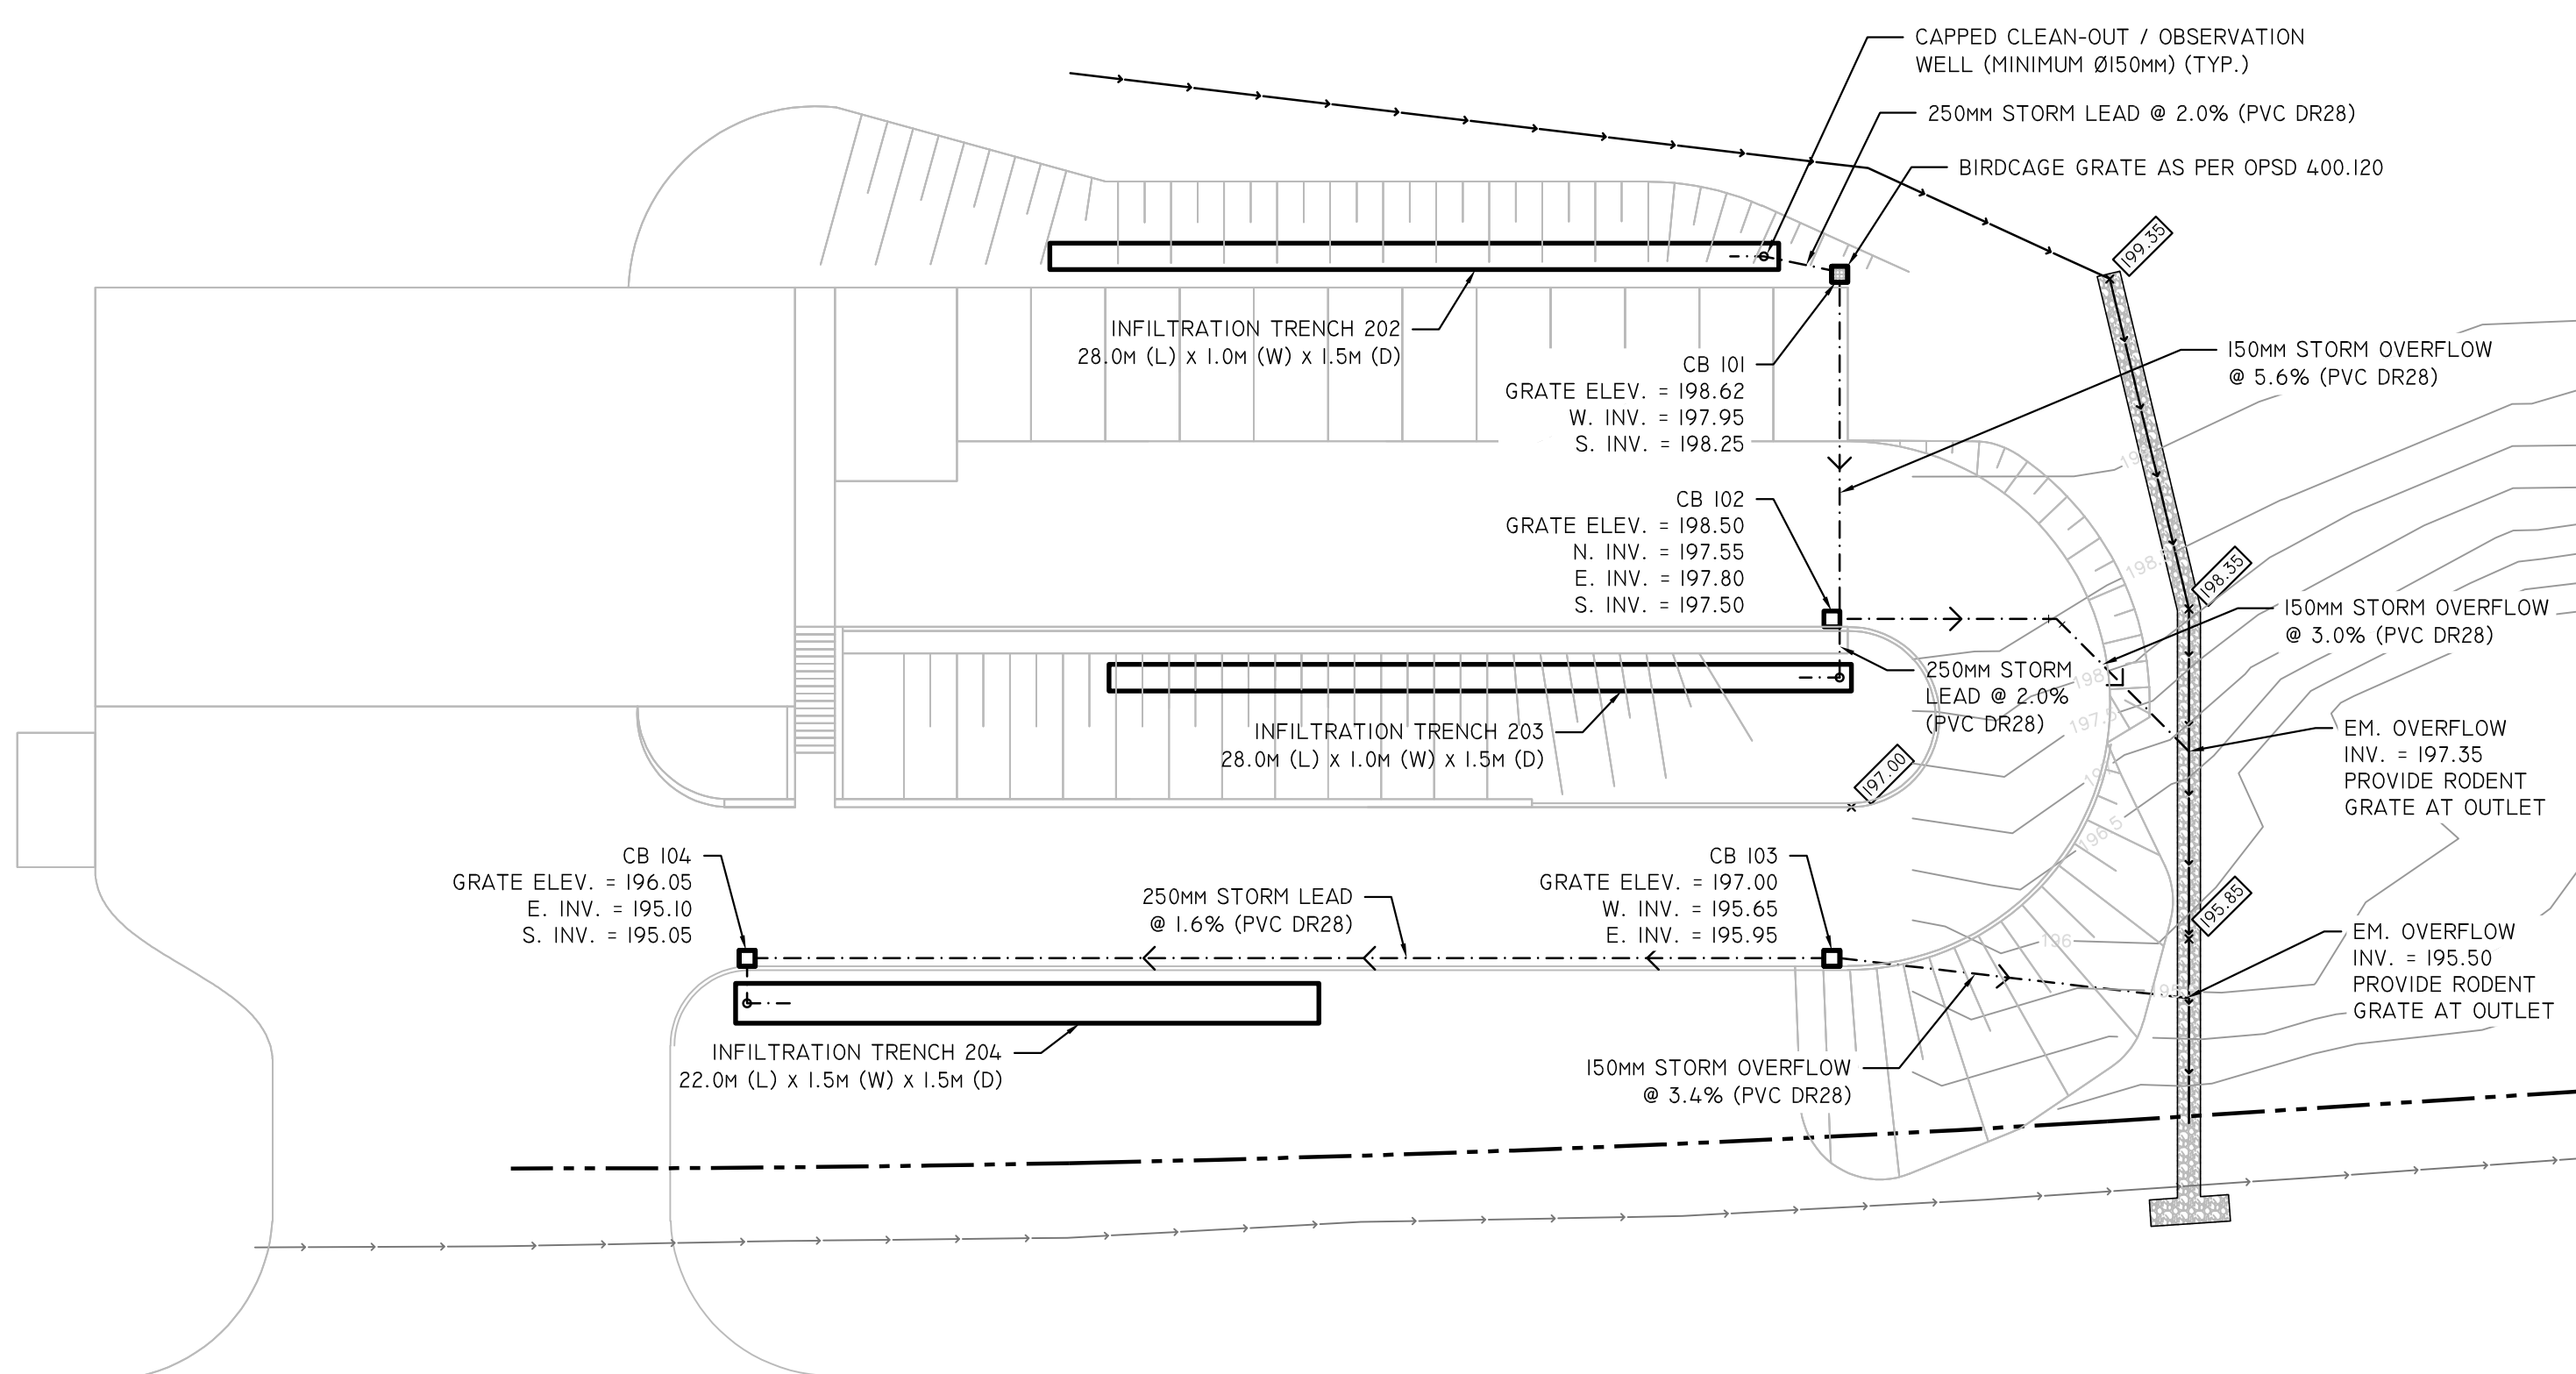


1 STORMWATER PIPE NETWORK & INFILTRATION TRENCH
SCALE: 1:250

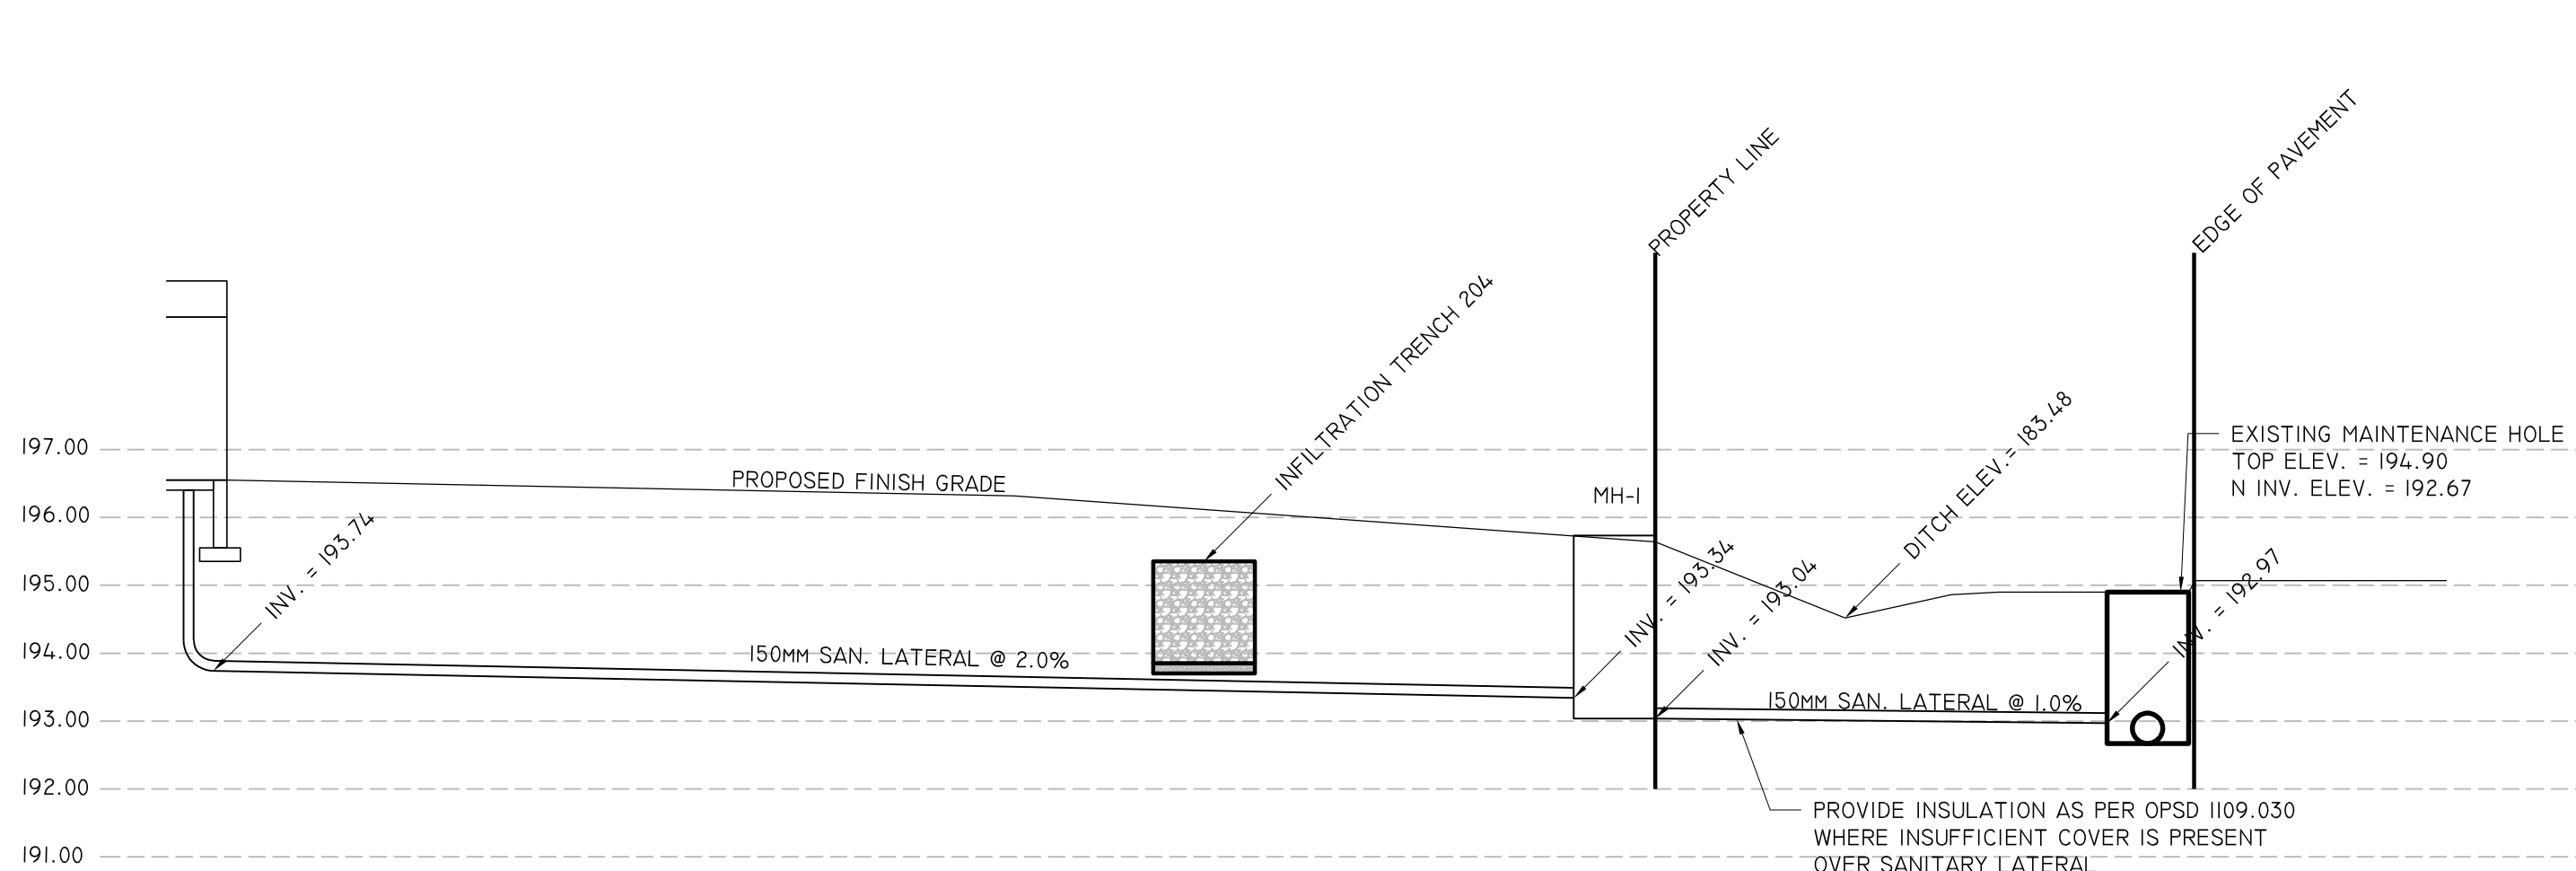


5 SANITARY SERVICING DETAIL
SCALE: 1:100

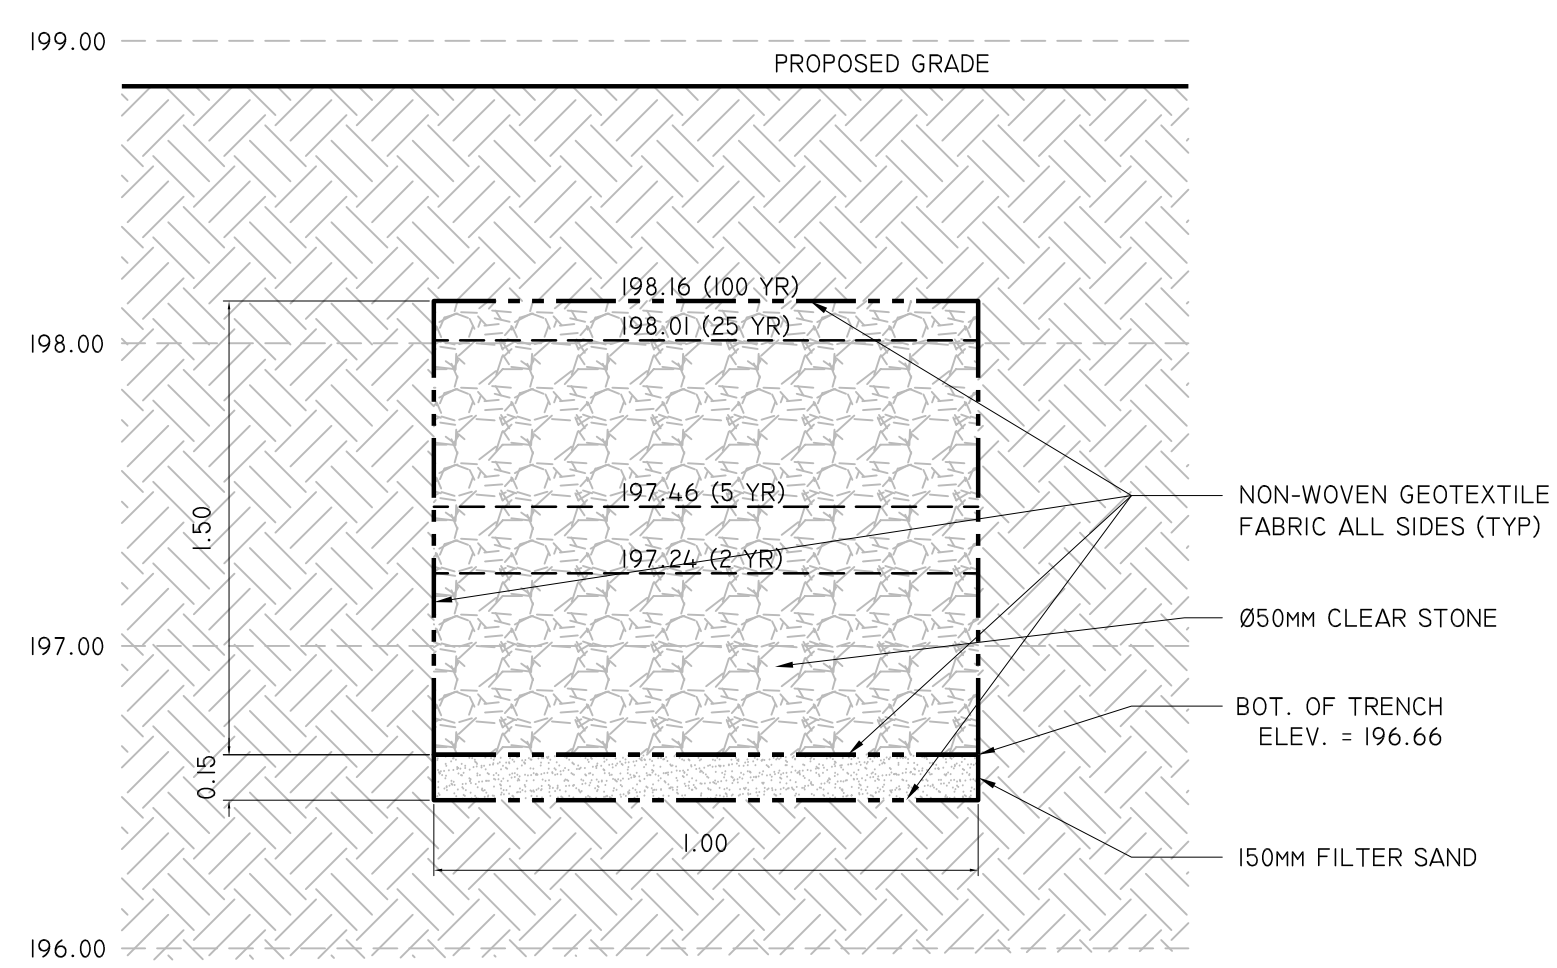


6 INFILTRATION TRENCH 202 DETAIL
SCALE: NTS

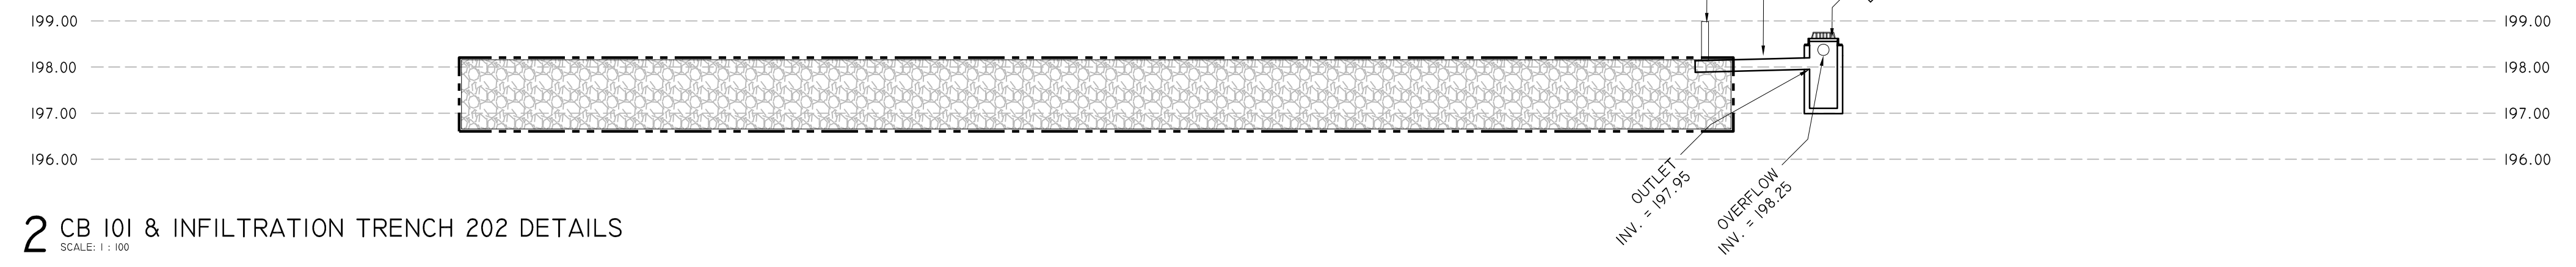


2 CB 101 & INFILTRATION TRENCH 202 DETAILS
SCALE: 1:100

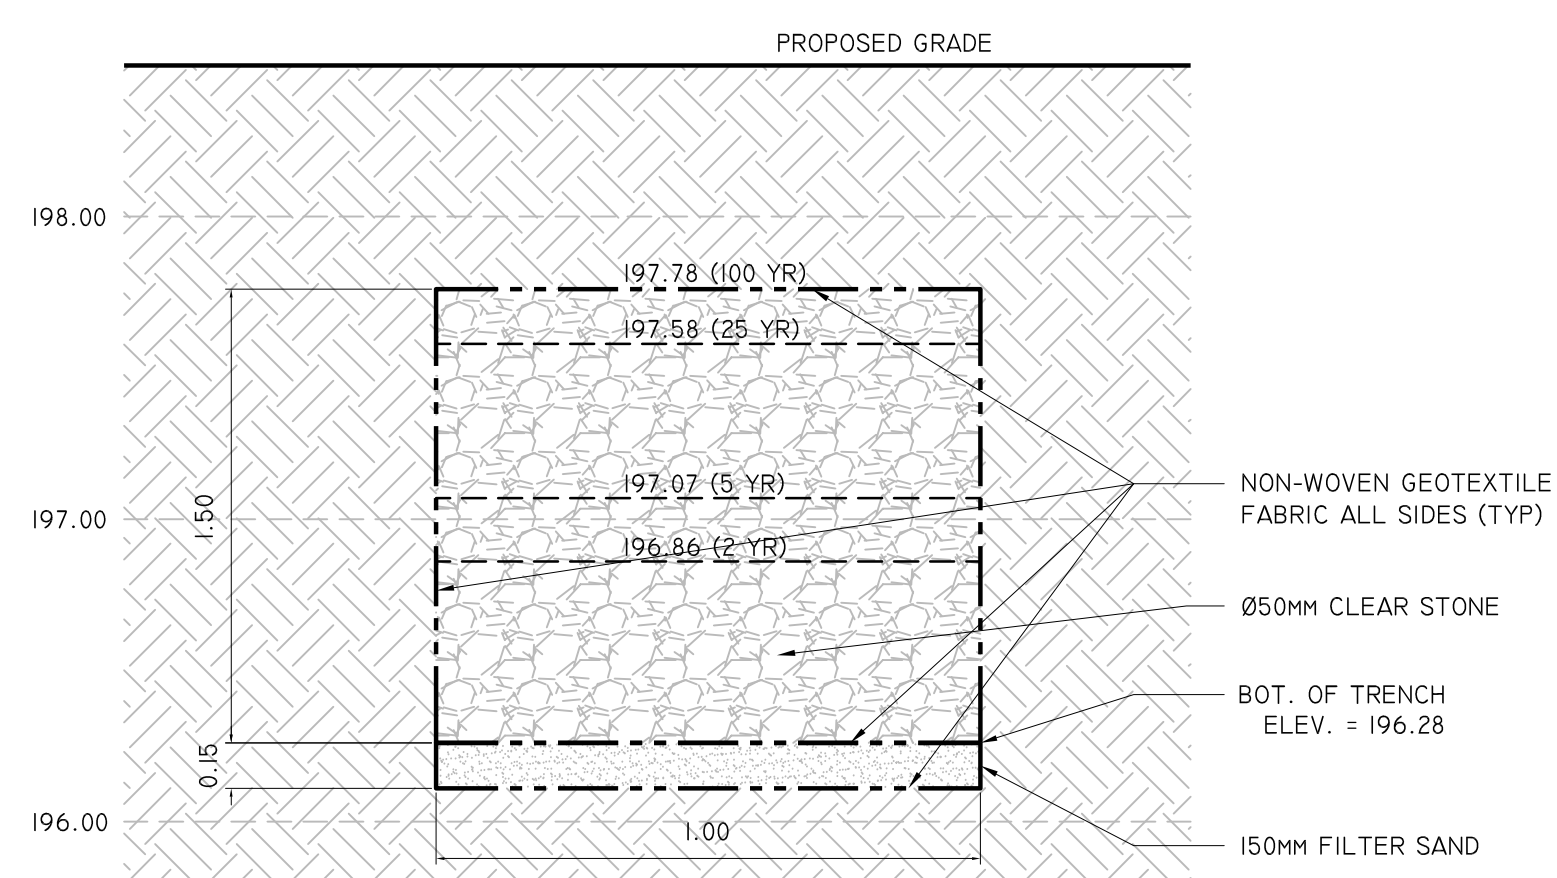


7 INFILTRATION TRENCH 203 DETAIL
SCALE: NTS

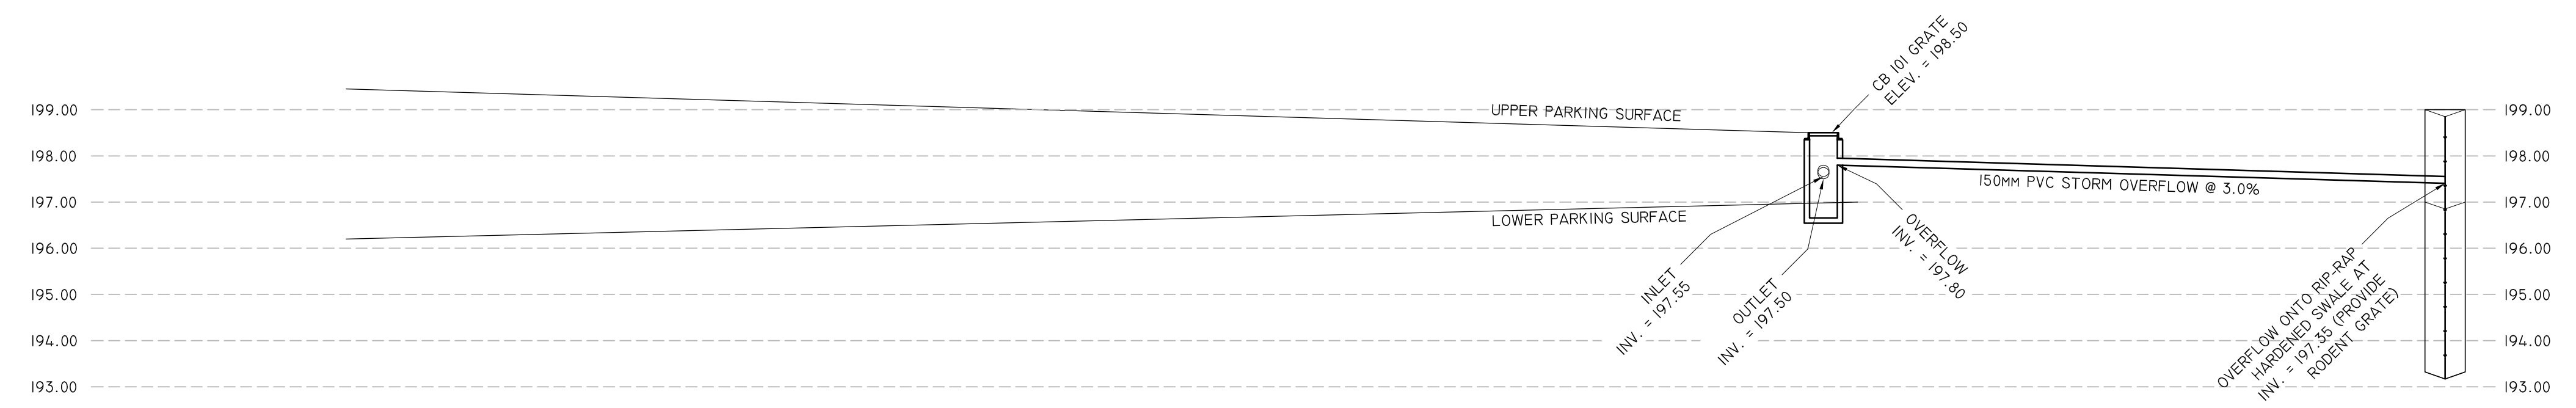


3 CB 102 DETAILS
SCALE: 1:100

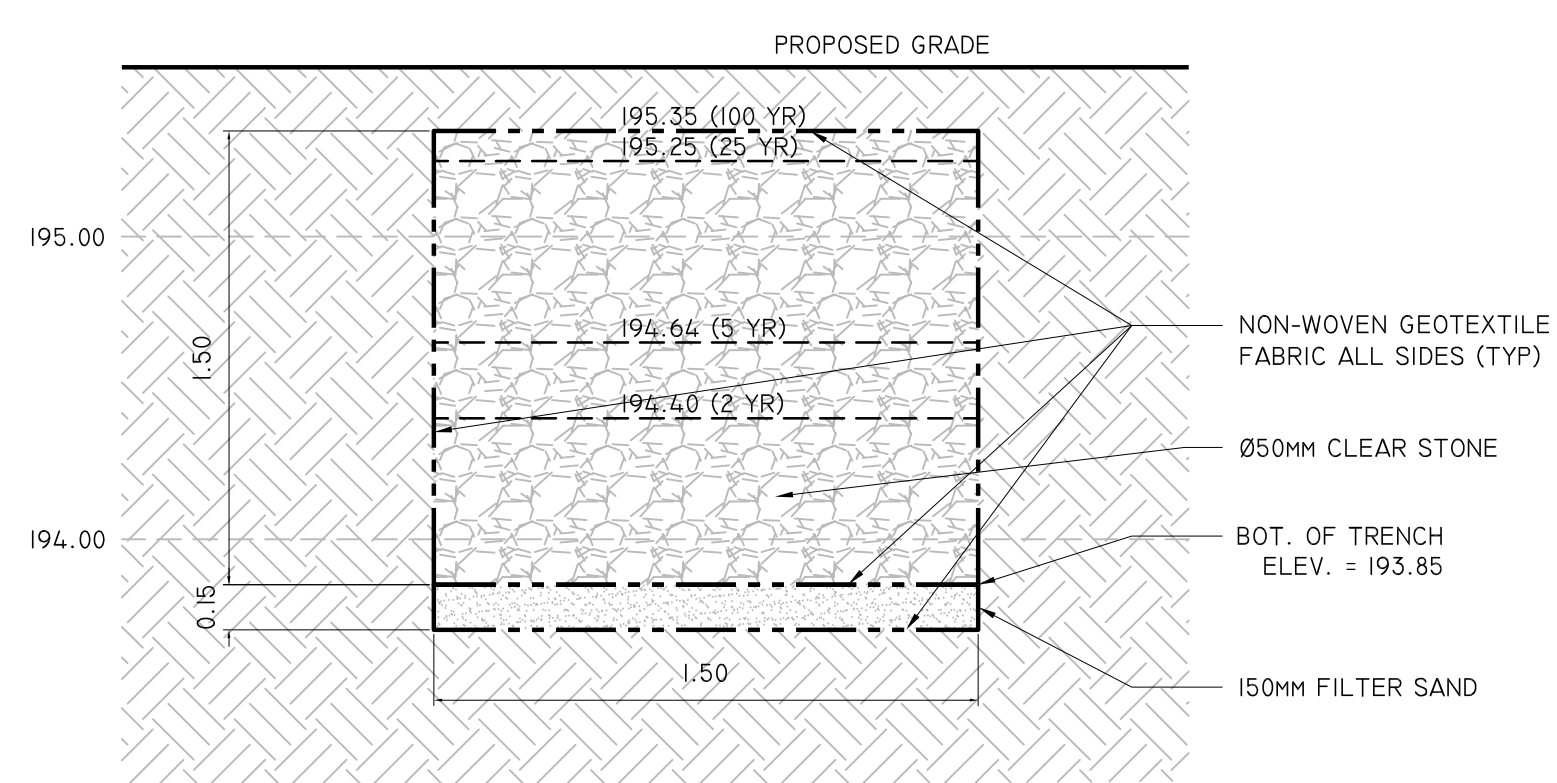













8 INFILTRATION TRENCH 204 DETAIL
SCALE: NTS

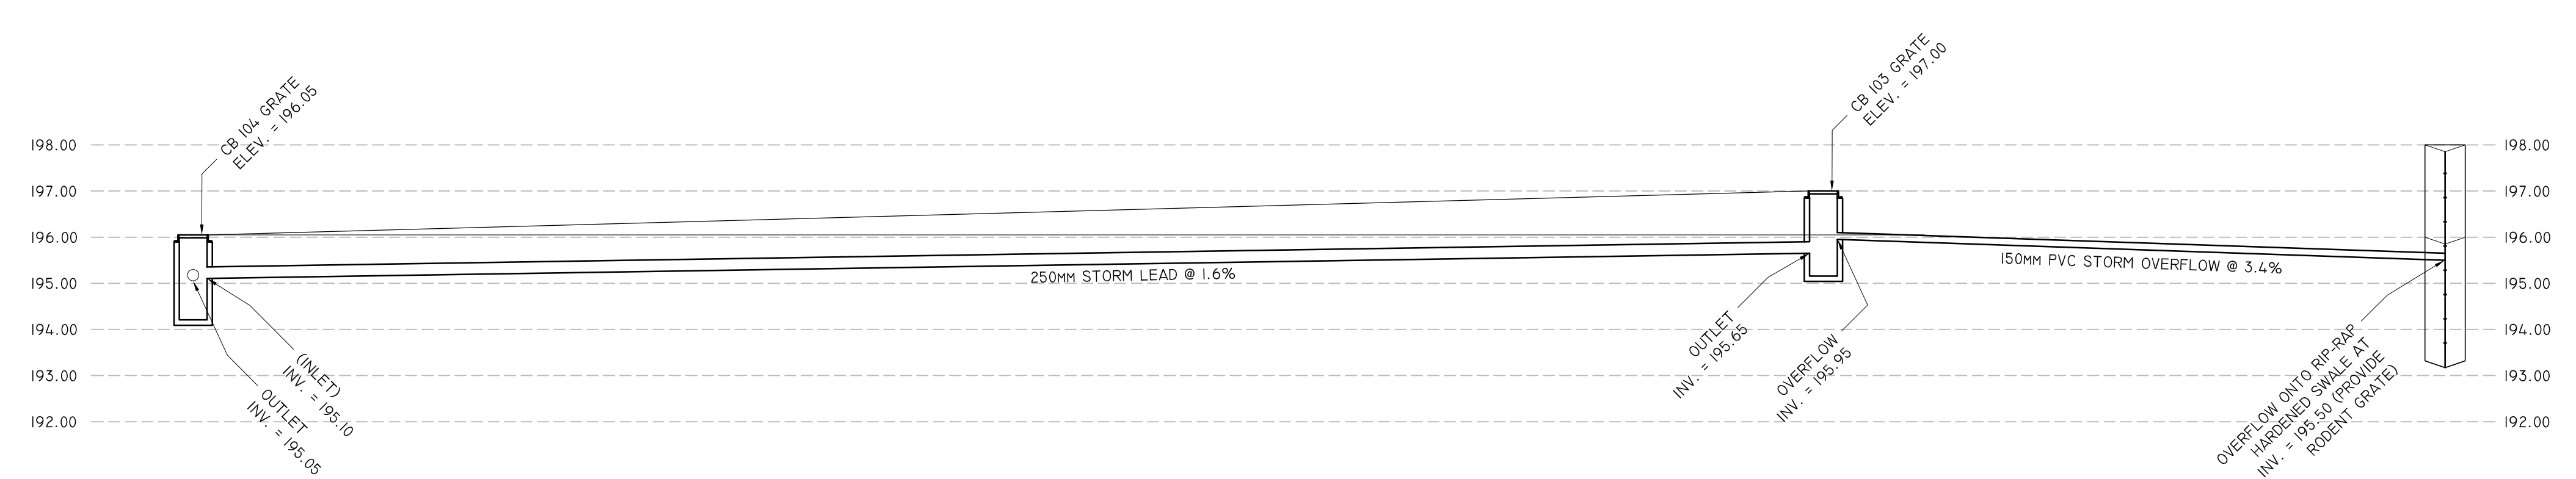

4 CB 103 & CB 104 DETAILS
SCALE: 1:100

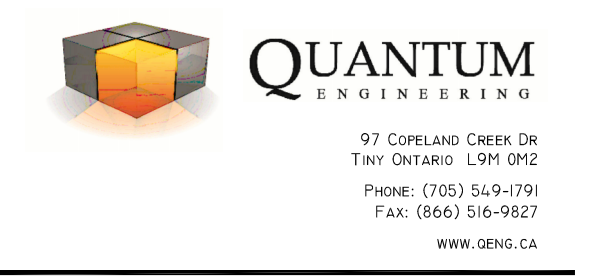

PROJECT: NEW COMMERCIAL FACILITY
 LOCATION: 120 PILLSBURY DR. MIDLAND, ONTARIO
 FOR: SCHULTZ - VANT SPYKER
 DRAWING: SWM & SANITARY
 DATE: DEC 2023 PROJECT NO: 6506 PAGE ID: C3
 DRAWN BY: D.L.W.
 SCALE: SEE PLOT

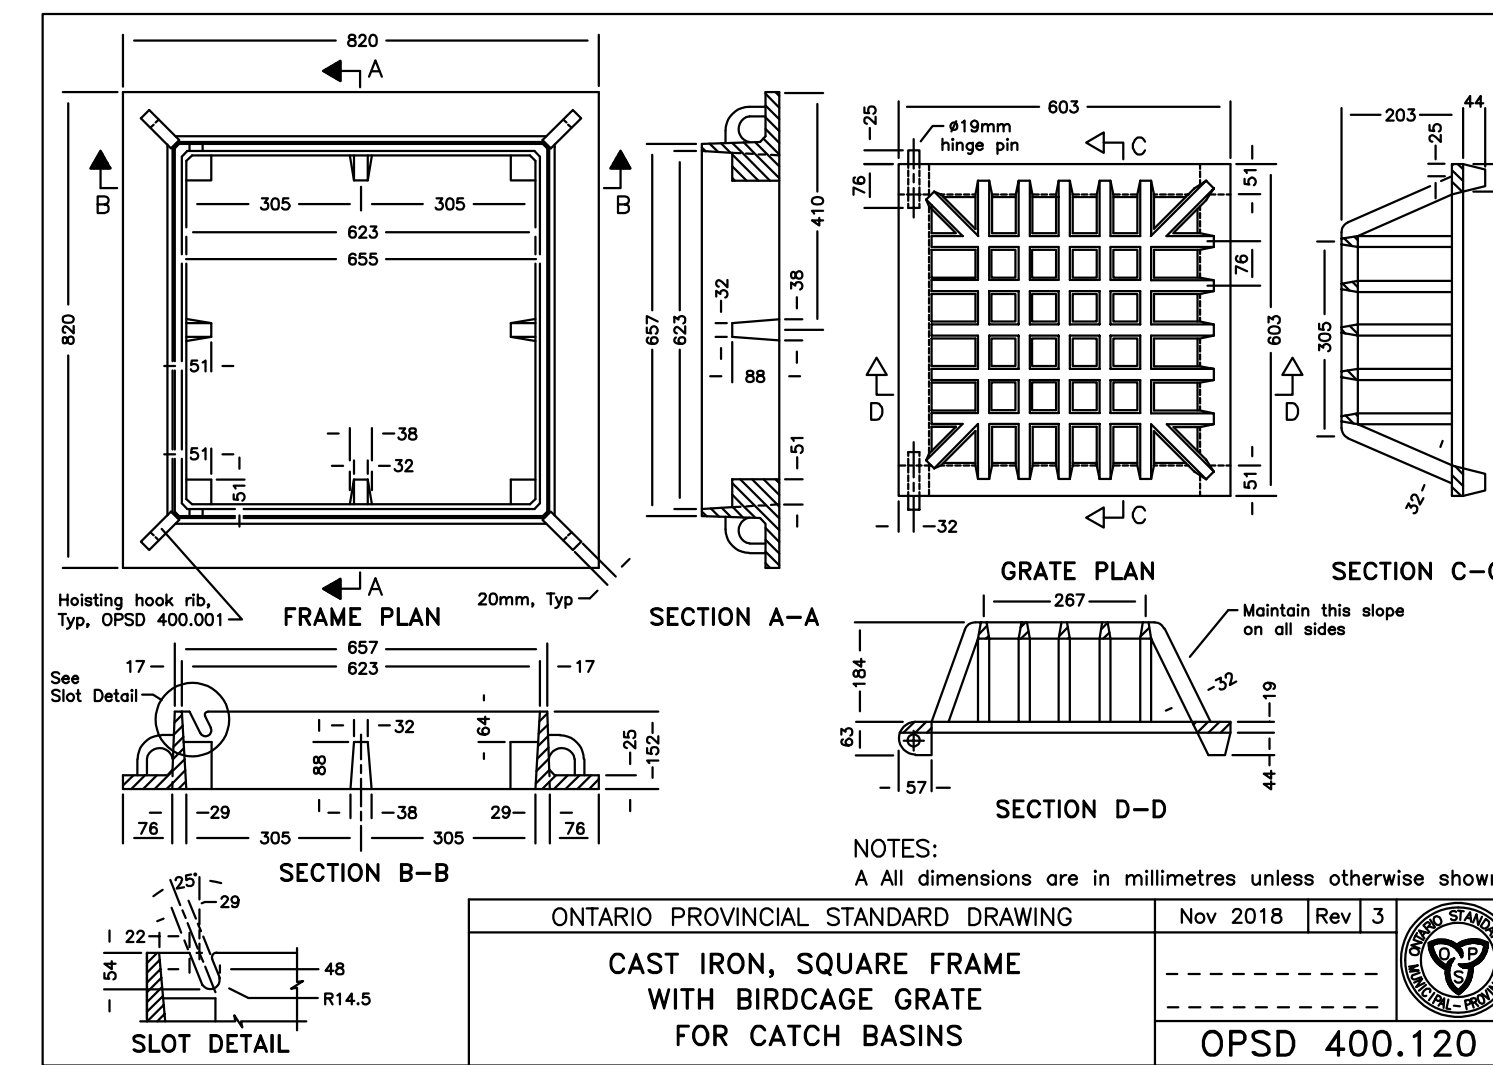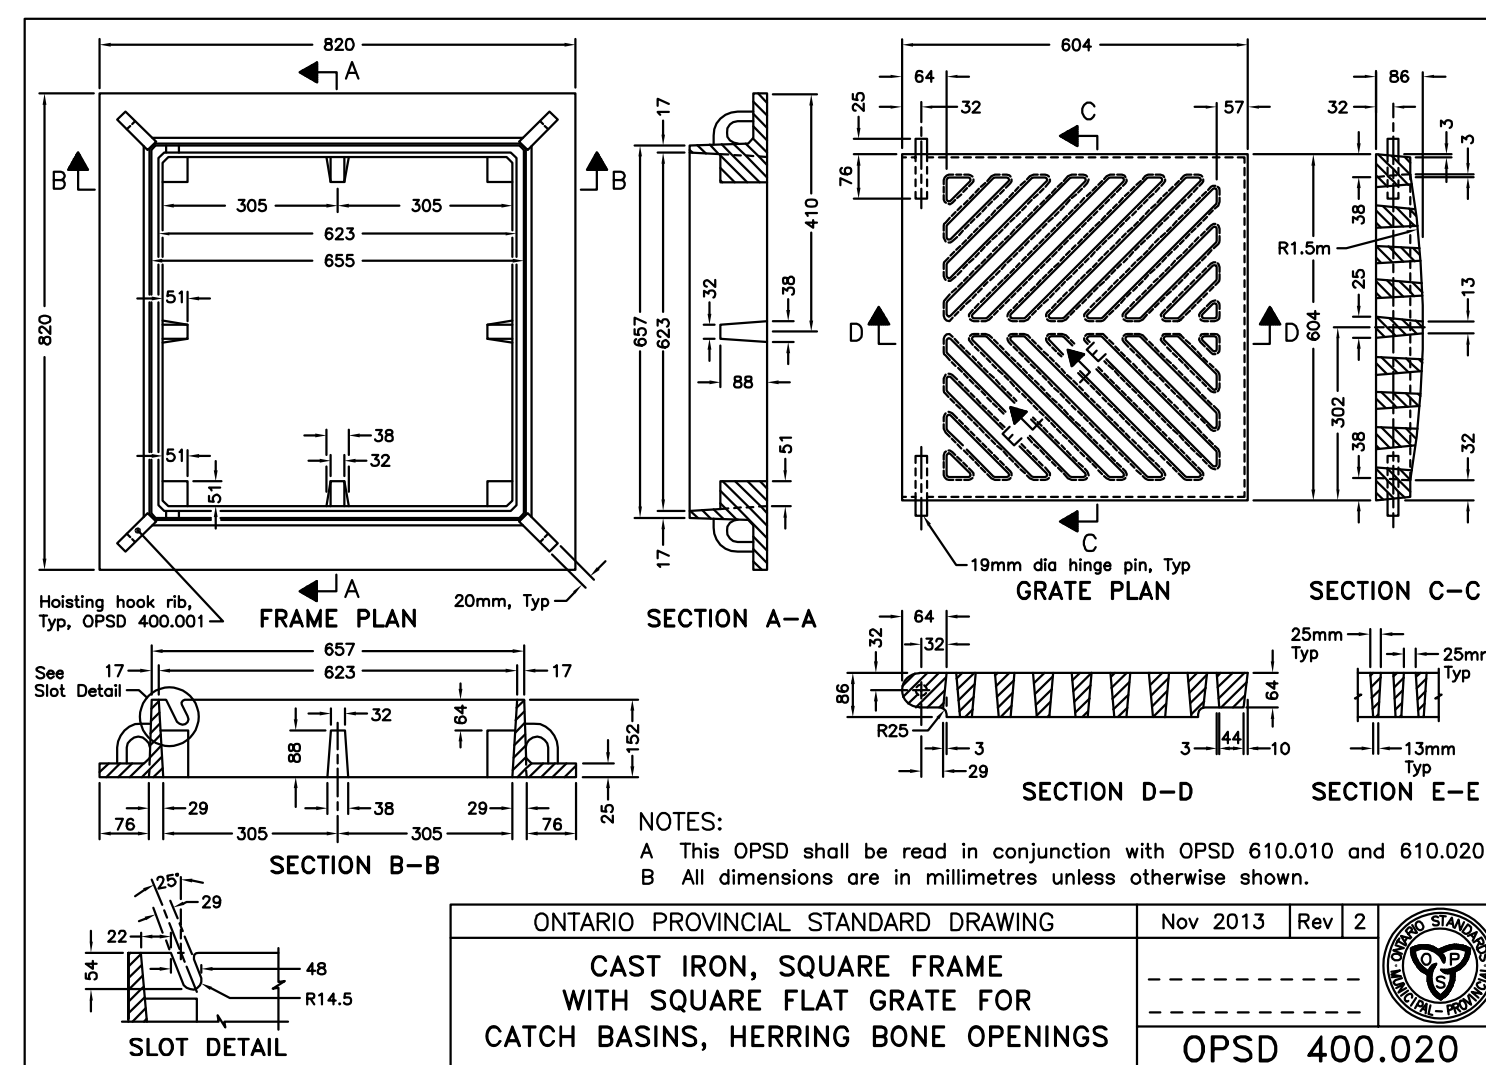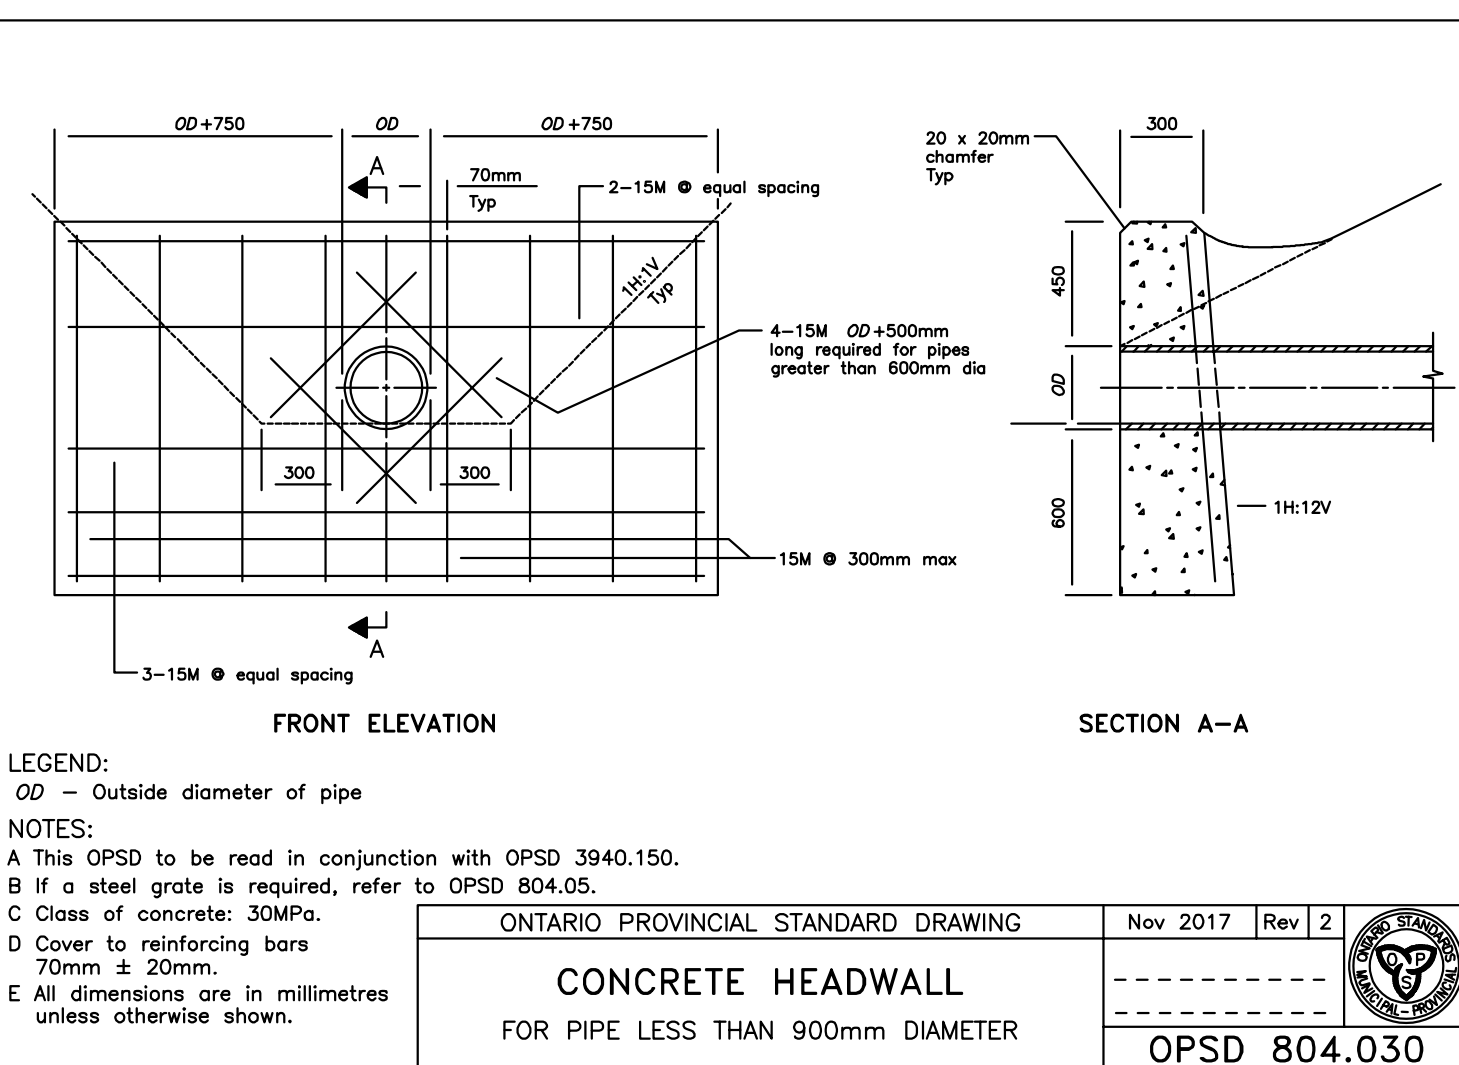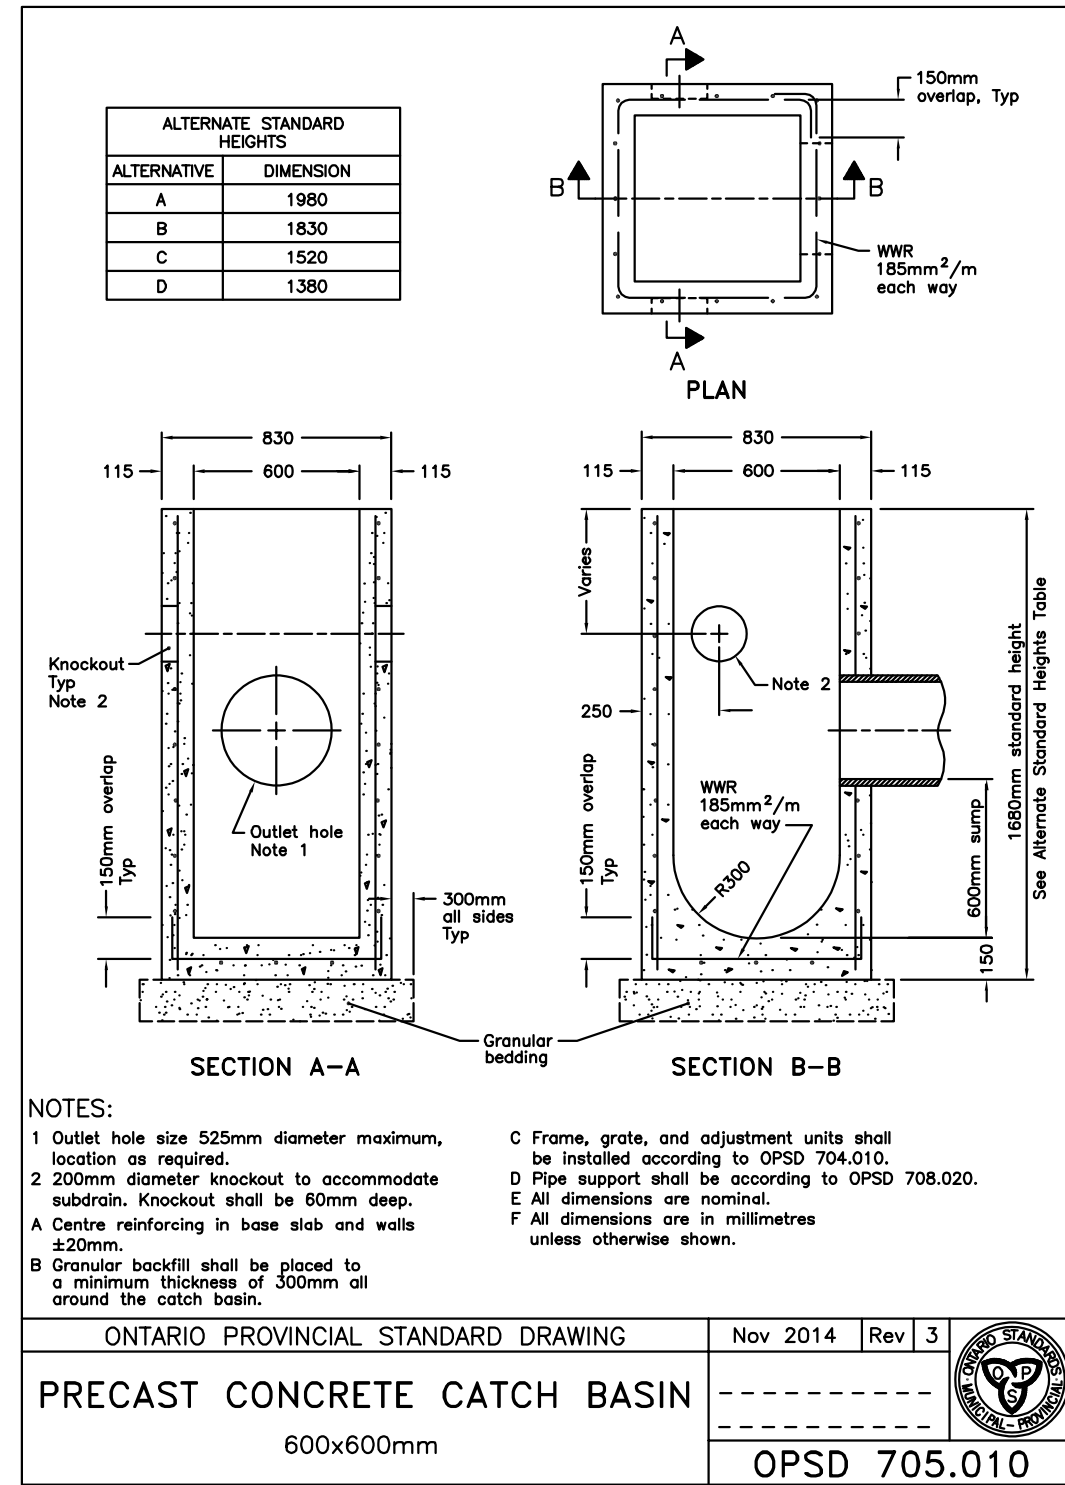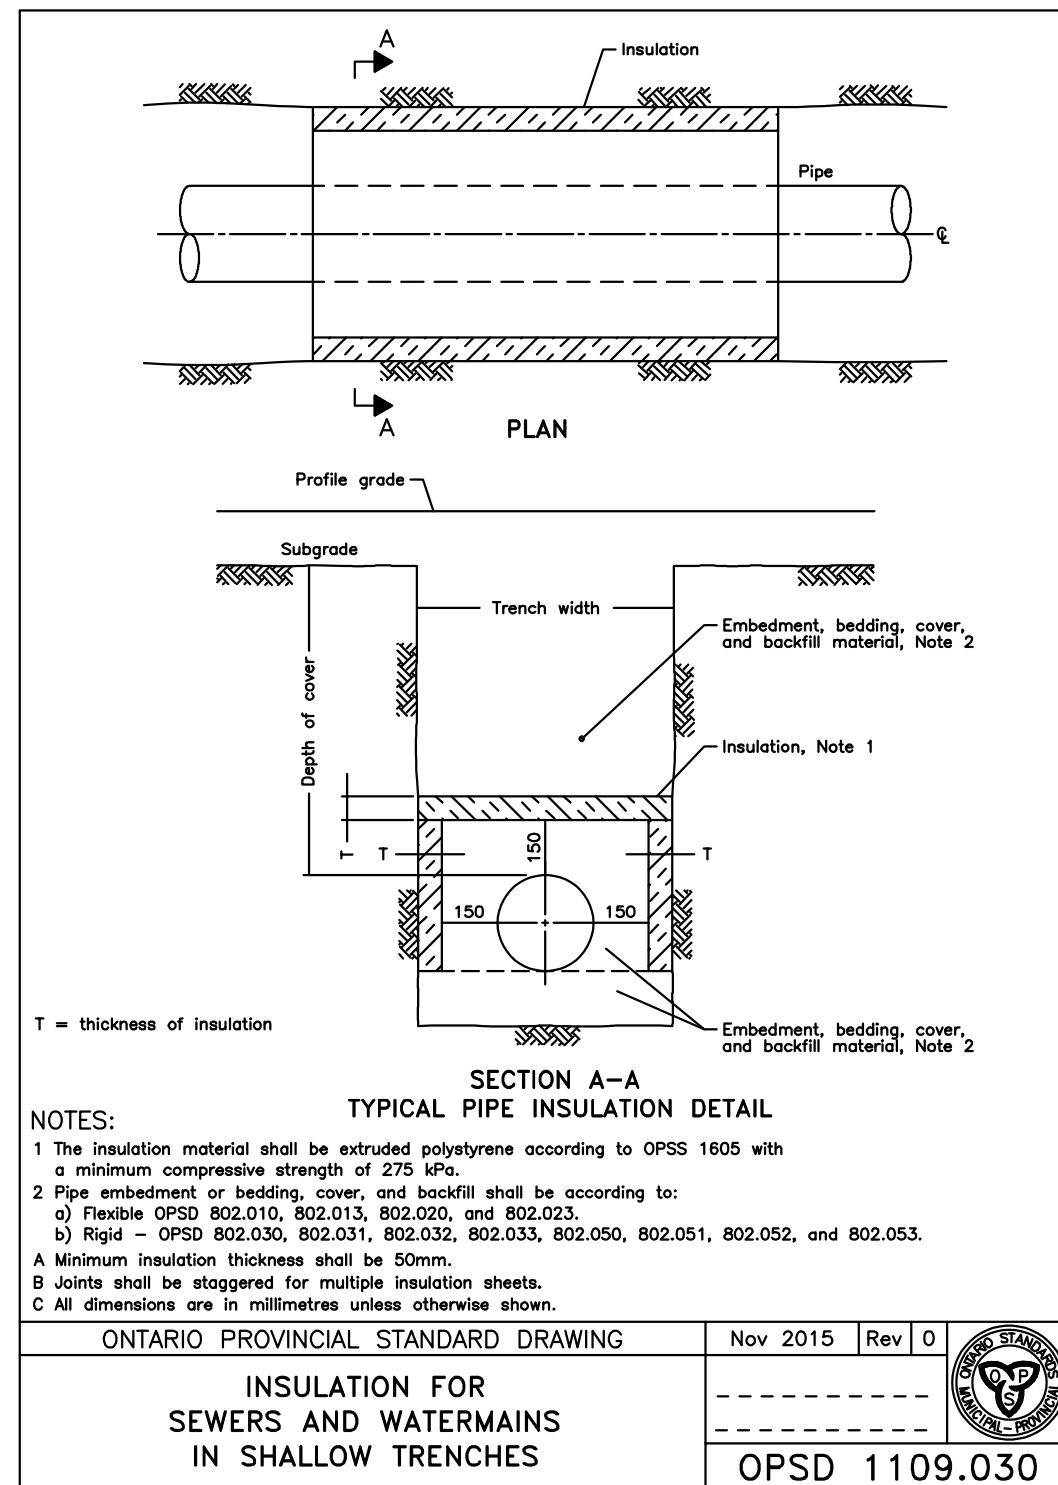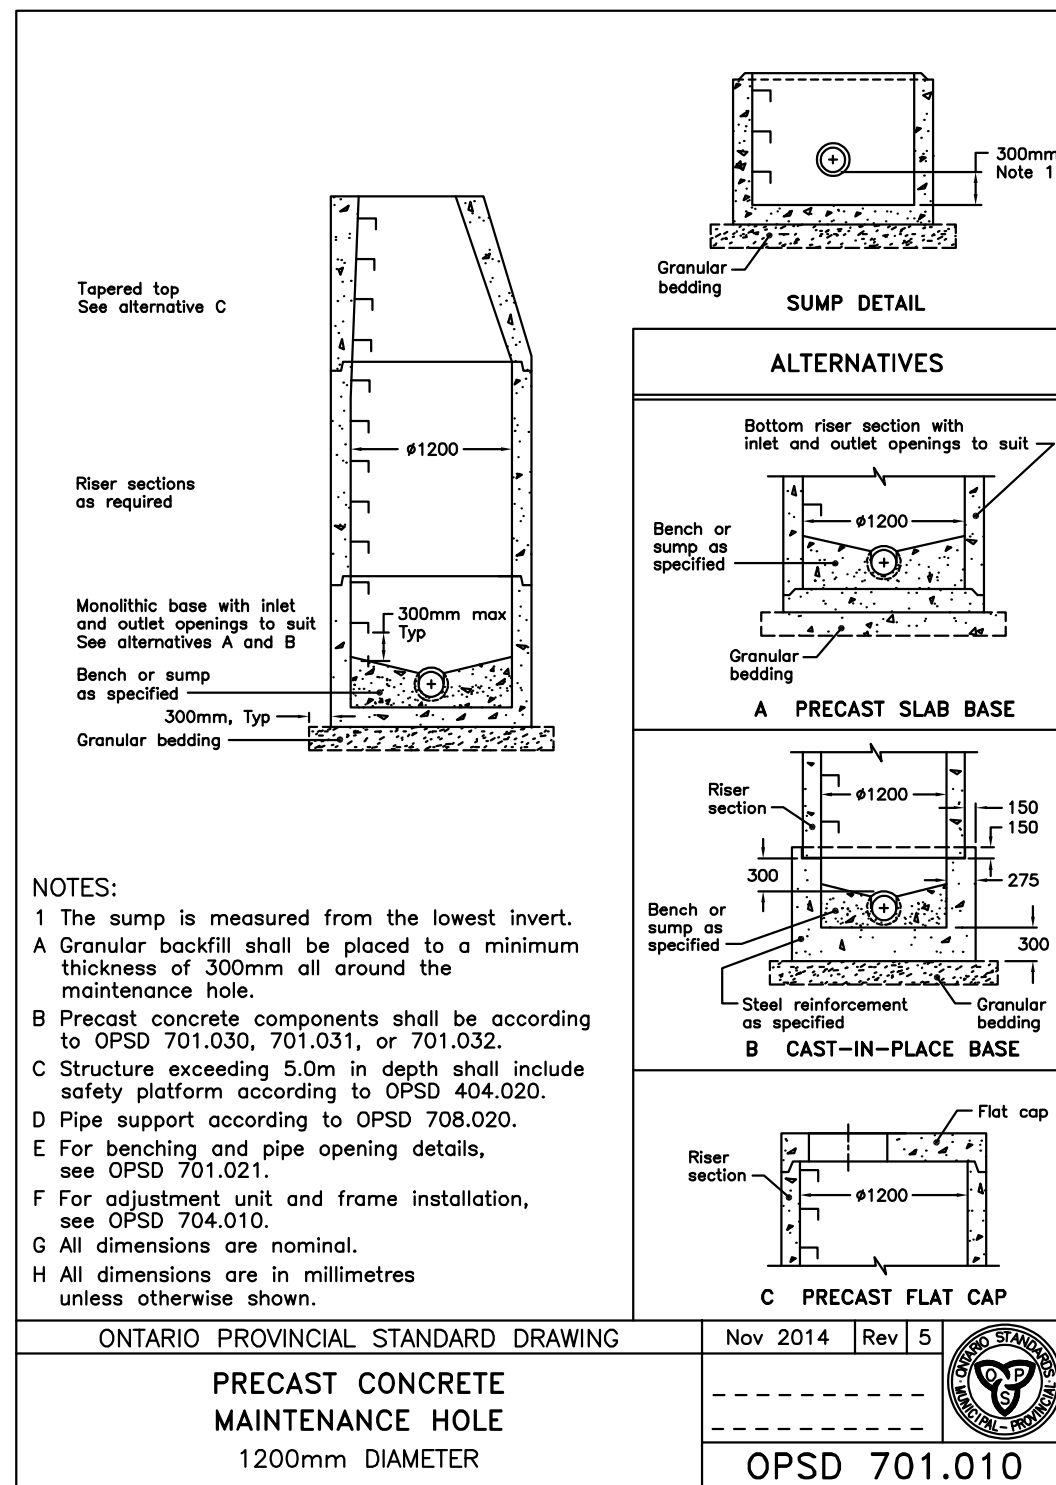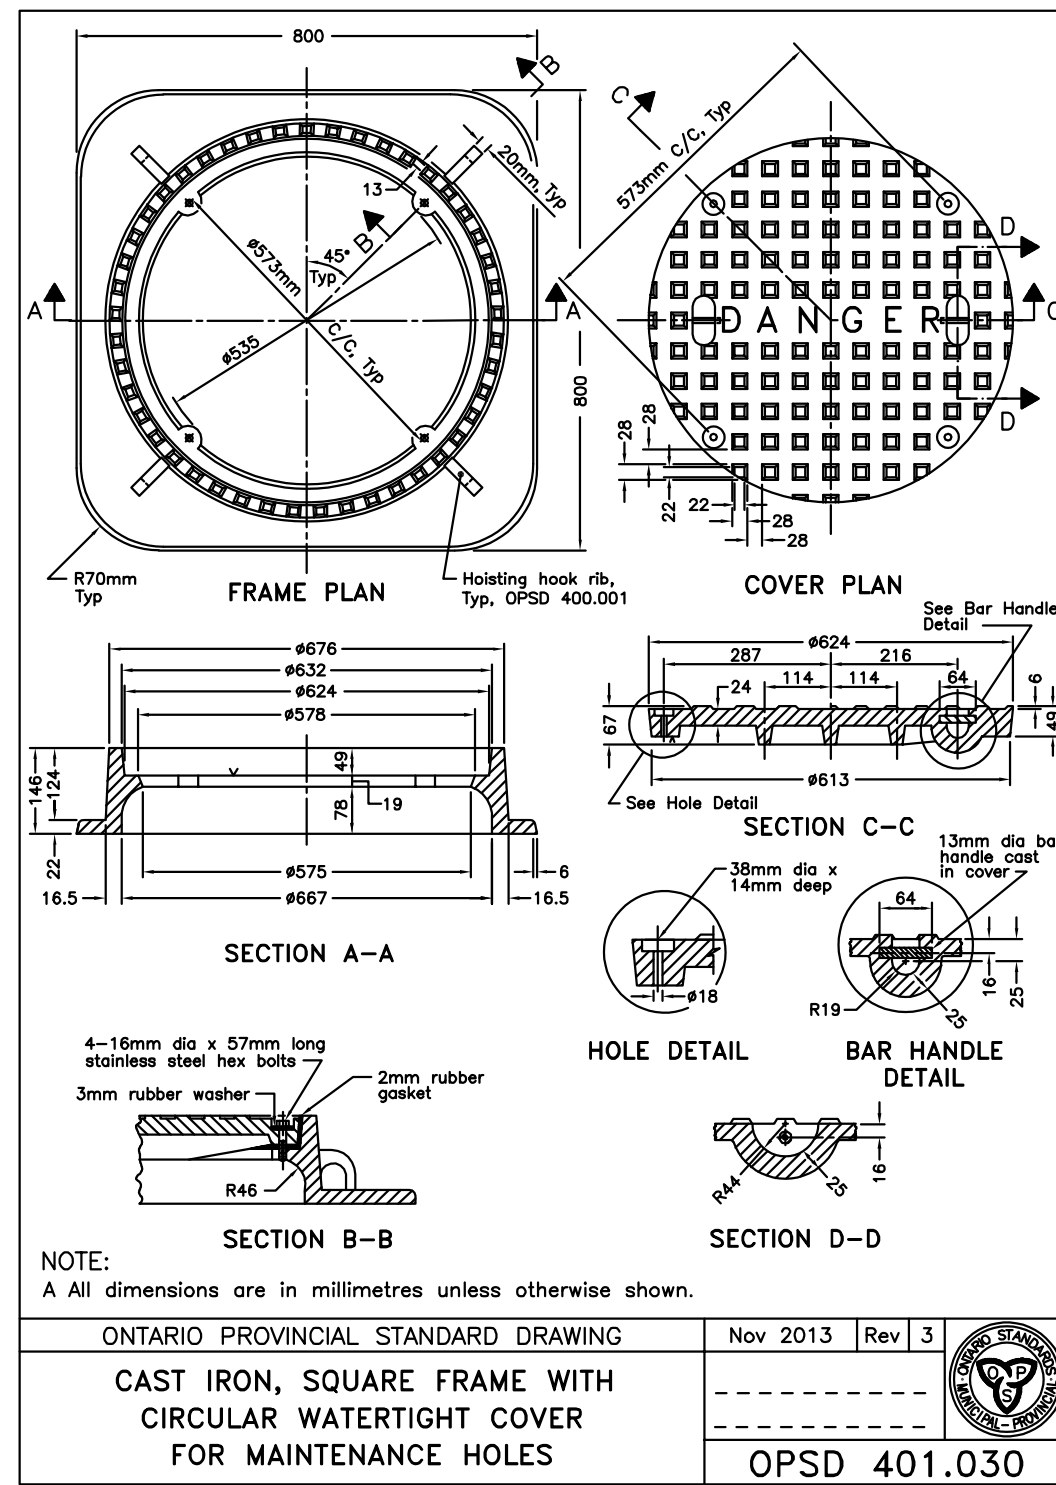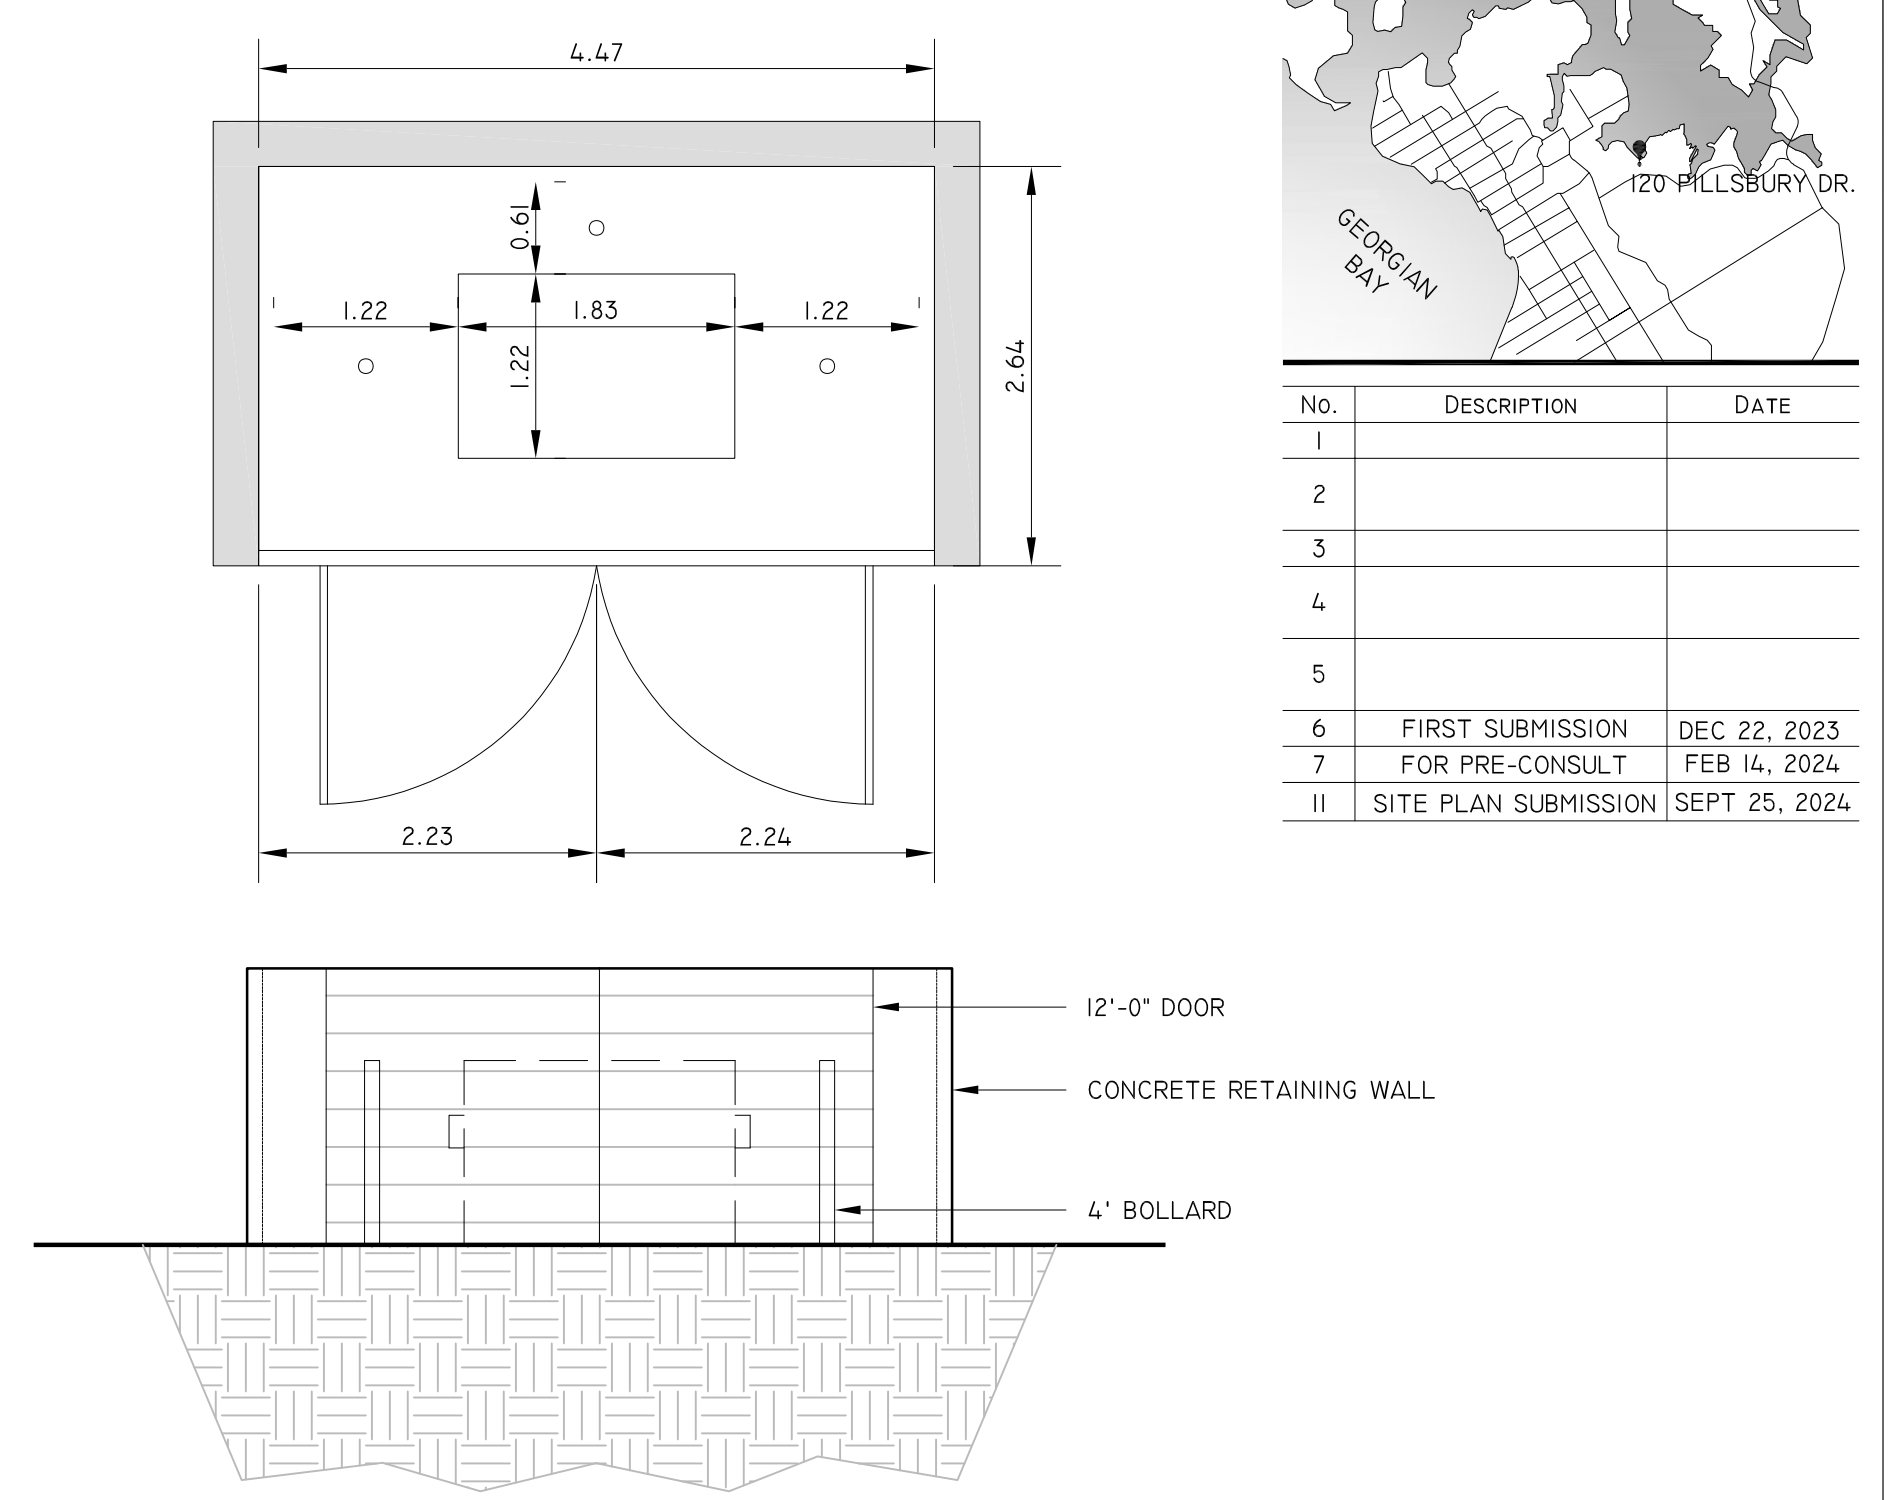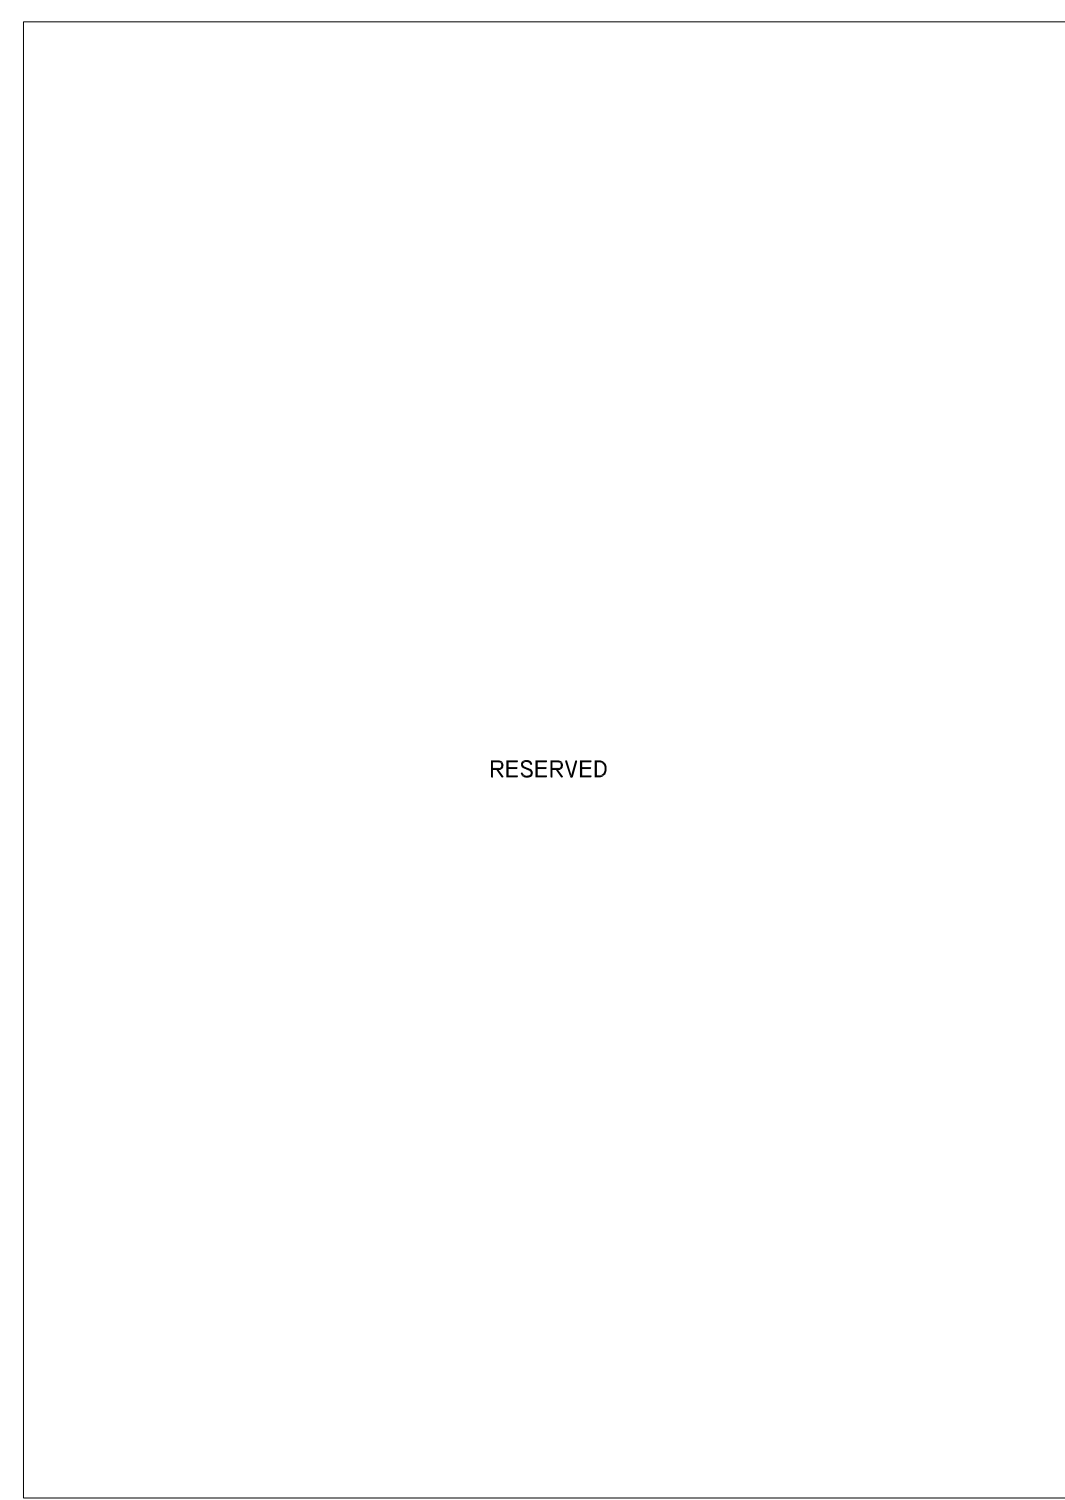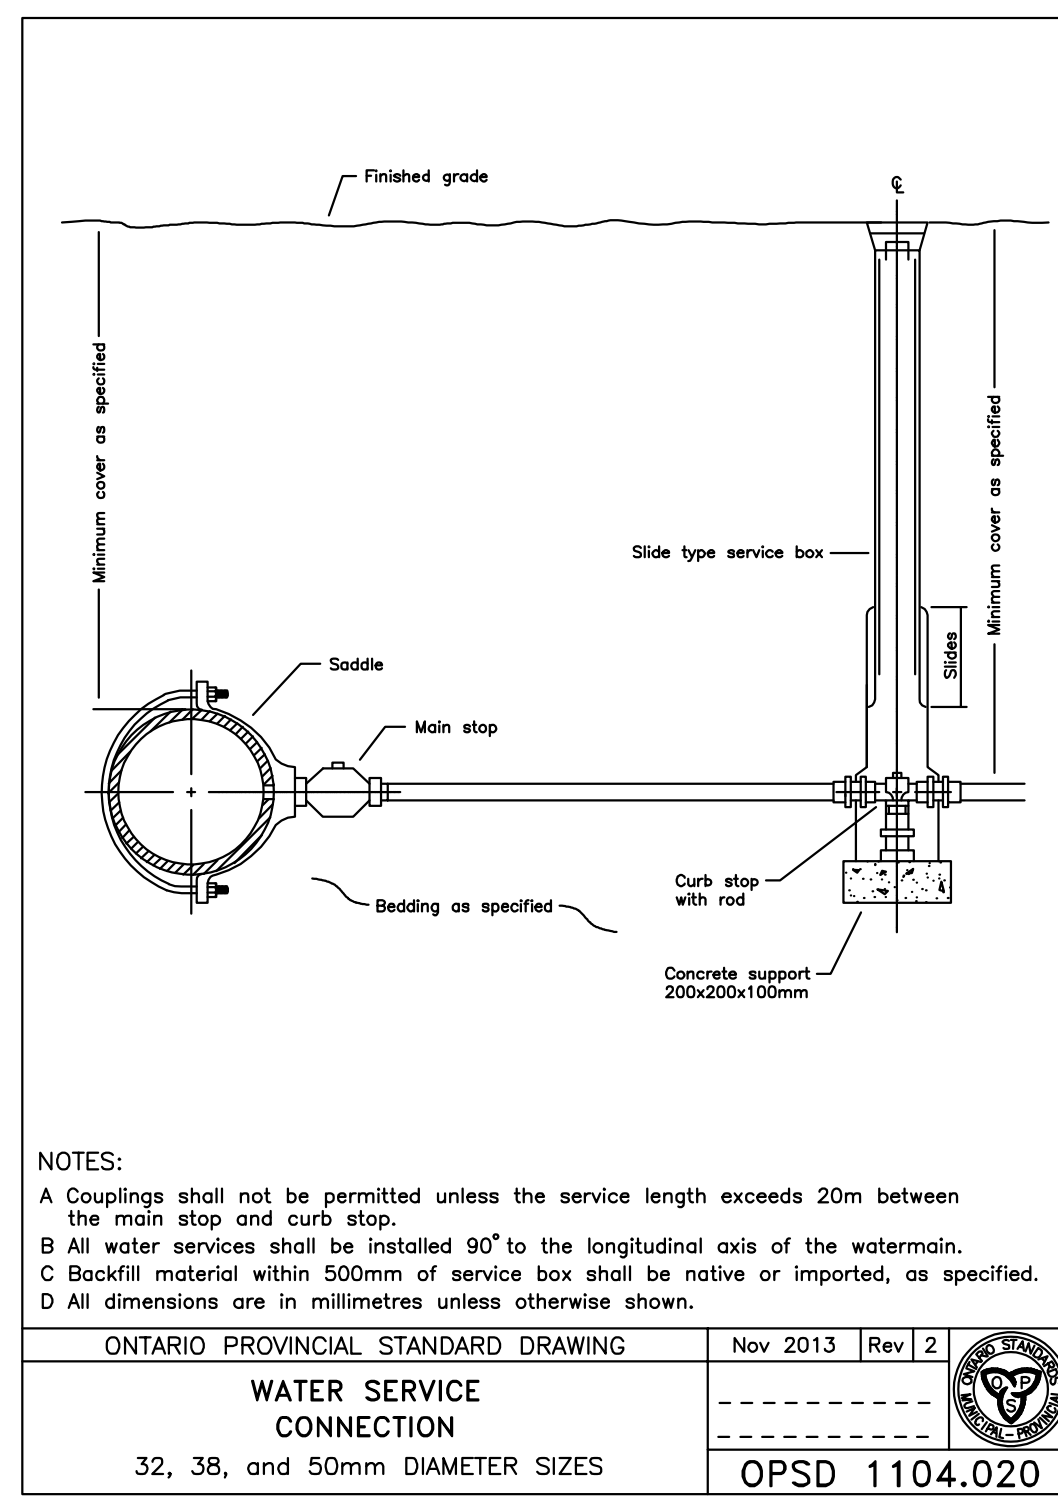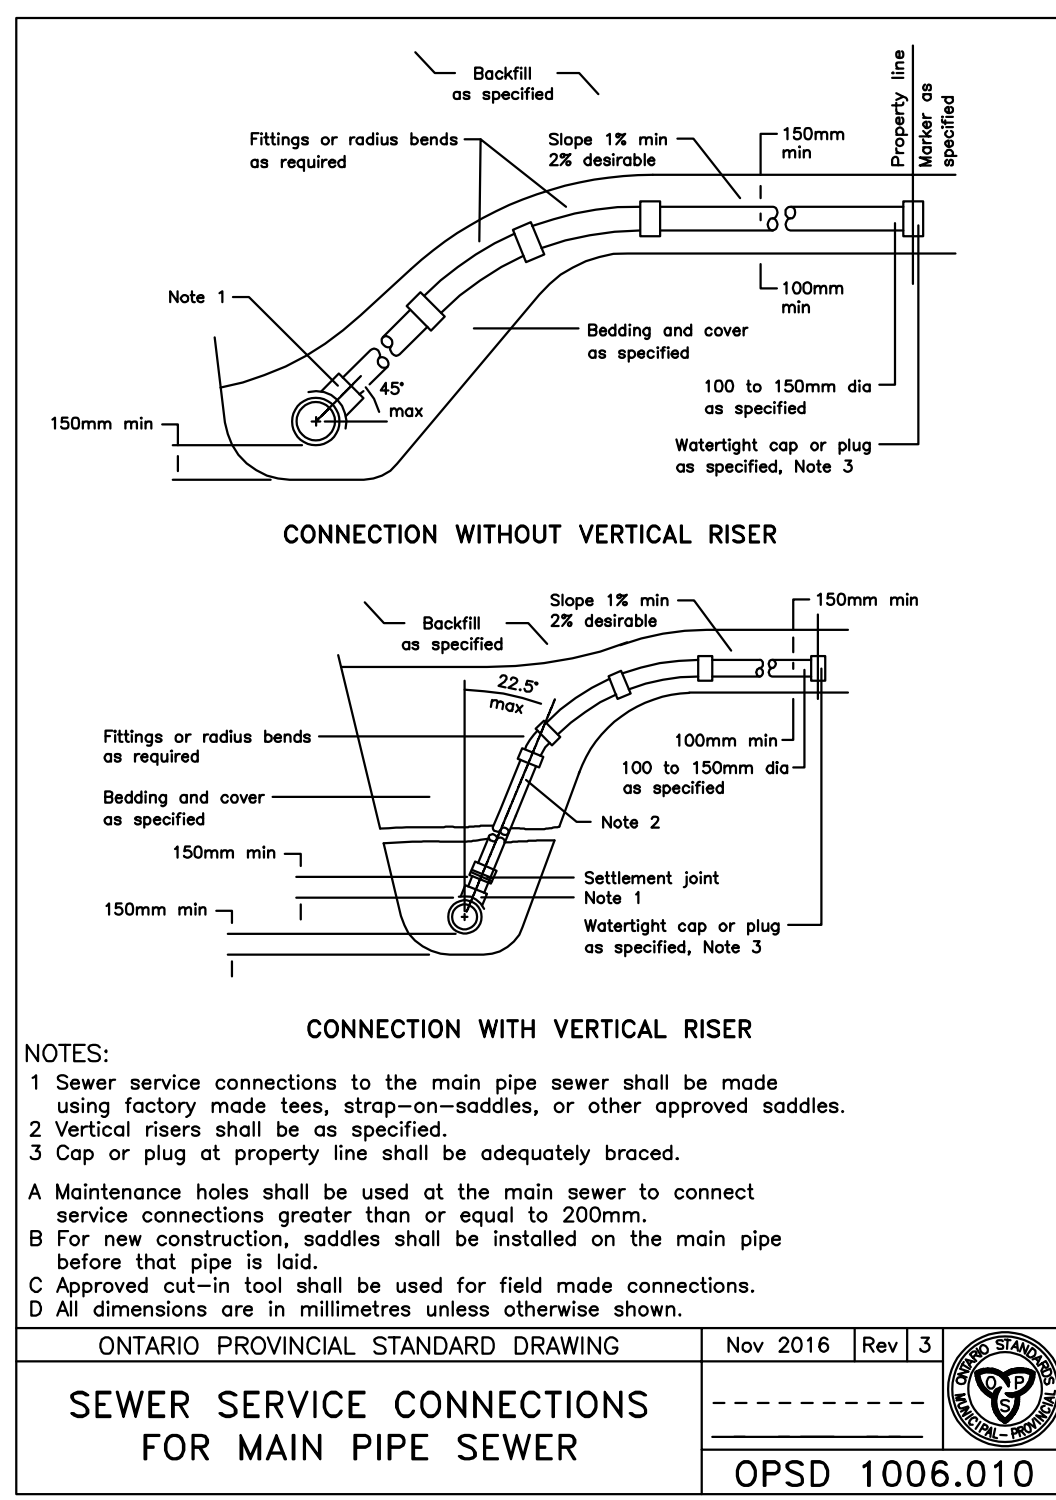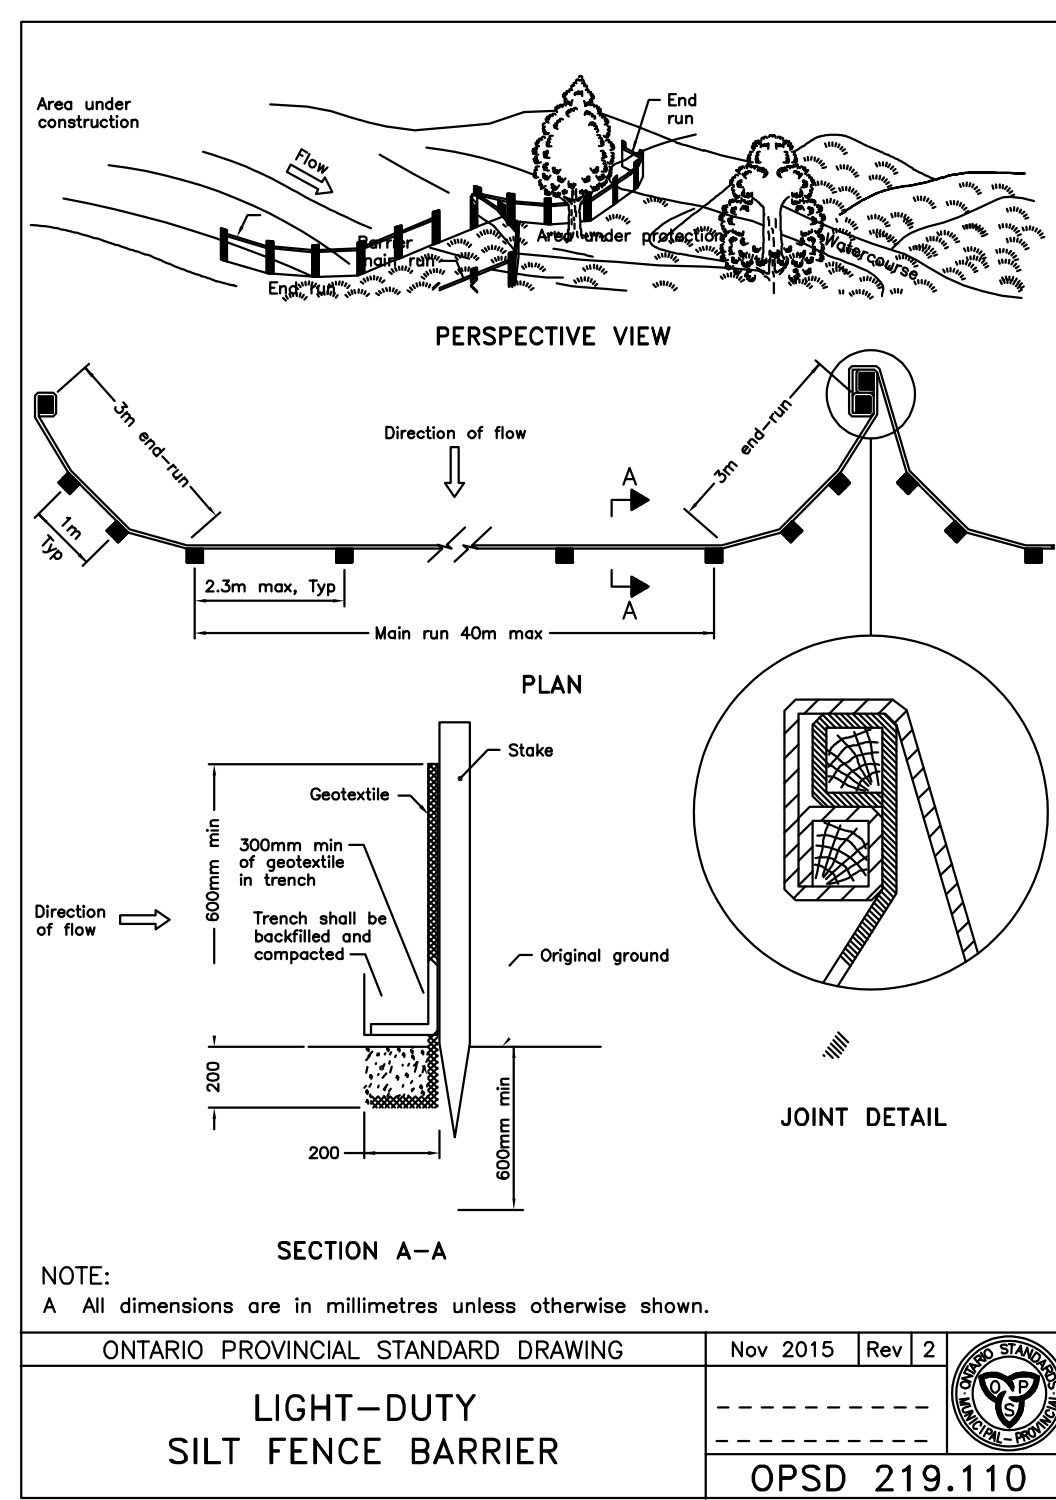

No.	DESCRIPTION	DATE
1		
2		
3		
4		
5		
6	FIRST SUBMISSION	DEC 22, 2023
7	FOR PRE-CONSULT	FEB 14, 2024
II	SITE PLAN SUBMISSION	SEPT 25, 2024



PROJECT: **NEW COMMERCIAL FACILITY**

LOCATION: 120 PILLSBURY DR. MIDLAND, ONTARIO

FOR: SCHULTZ - VANT SPYKER

DRAWING: **DETAILS**

DATE	PROJECT NO.	PAGE ID
DEC 2023		

DRAWN BY: D.L.W. **6506** **C4**

SCALE: SEE PLOT

LIGHTING SCHEDULE						
Label	Quantity	Name	Catalog Number	Size / Height	Mounting	Volts
L1	3	LITHONIA LIGHTING	DSX2 LED P1 40K T2M MVOLT RPA NLTAR2 PIRHM DELXD	6 M	POLE	120V 1P 2W
L2	3	LITHONIA LIGHTING	DSXW2 LED 200 350 40K T3S MVOLT PIR DELXD	2.44 M @ DOORS	WALL	120V 1P 2W


THIS DRAWING INDICATES ALL PROPOSED OUTDOOR LIGHTING FIXTURES FOR THIS PROPOSED DEVELOPMENT. THE LIGHTING DESIGN IS IN ACCORDANCE WITH THE APPLICABLE LIGHTING ZONE AS ESTABLISHED BY THE TOWN OF MIDLAND, AND DESIGNED WITH AN AVERAGE TO MINIMUM RATIO IN ACCORDANCE WITH THE ILLUMINATING ENGINEERING SOCIETY GUIDELINES. THIS LIGHTING DESIGN WILL NOT CREATE ANY OBJECTIONABLE GLARE FOR ADJACENT PROPERTIES.

PARKING LOT PHOTOMETRIC SCHEDULE	
MINIMUM FOOT-CANDELES	0.0
AVERAGE FOOT-CANDELES	0.76
MAXIMUM FOOT-CANDELES	7.0
MAX:MIN FC RATIO	7.01:0.00
AVG:MIN FC RATIO	0.76:0.00





EXTERIOR LIGHTING:
 1) ALL LIGHTING TO MEET REQUIREMENTS OF TOWN OF MIDLAND LIGHTING GUIDELINES.
 2) ALL SECURITY LIGHTING TO BE SHIELDED SO THAT LIGHT DOES NOT INFRINGE ON ADJACENT PROPERTIES (FULL CUT OFF) & WILL BE DARK SKY FRIENDLY.
 3) SEE LIGHTING SCHEDULE FOR MAKE AND MODELS.

PART OF THE
 WEST 1/2 LOT 18
 CONCESSION 3
 (GEOGRAPHIC TOWNSHIP OF TAY)
 TOWN OF MIDLAND
 COUNTY OF SIMCOE


BLOCK 18
 51M - 825
 PIN 58475-0512 (LT)

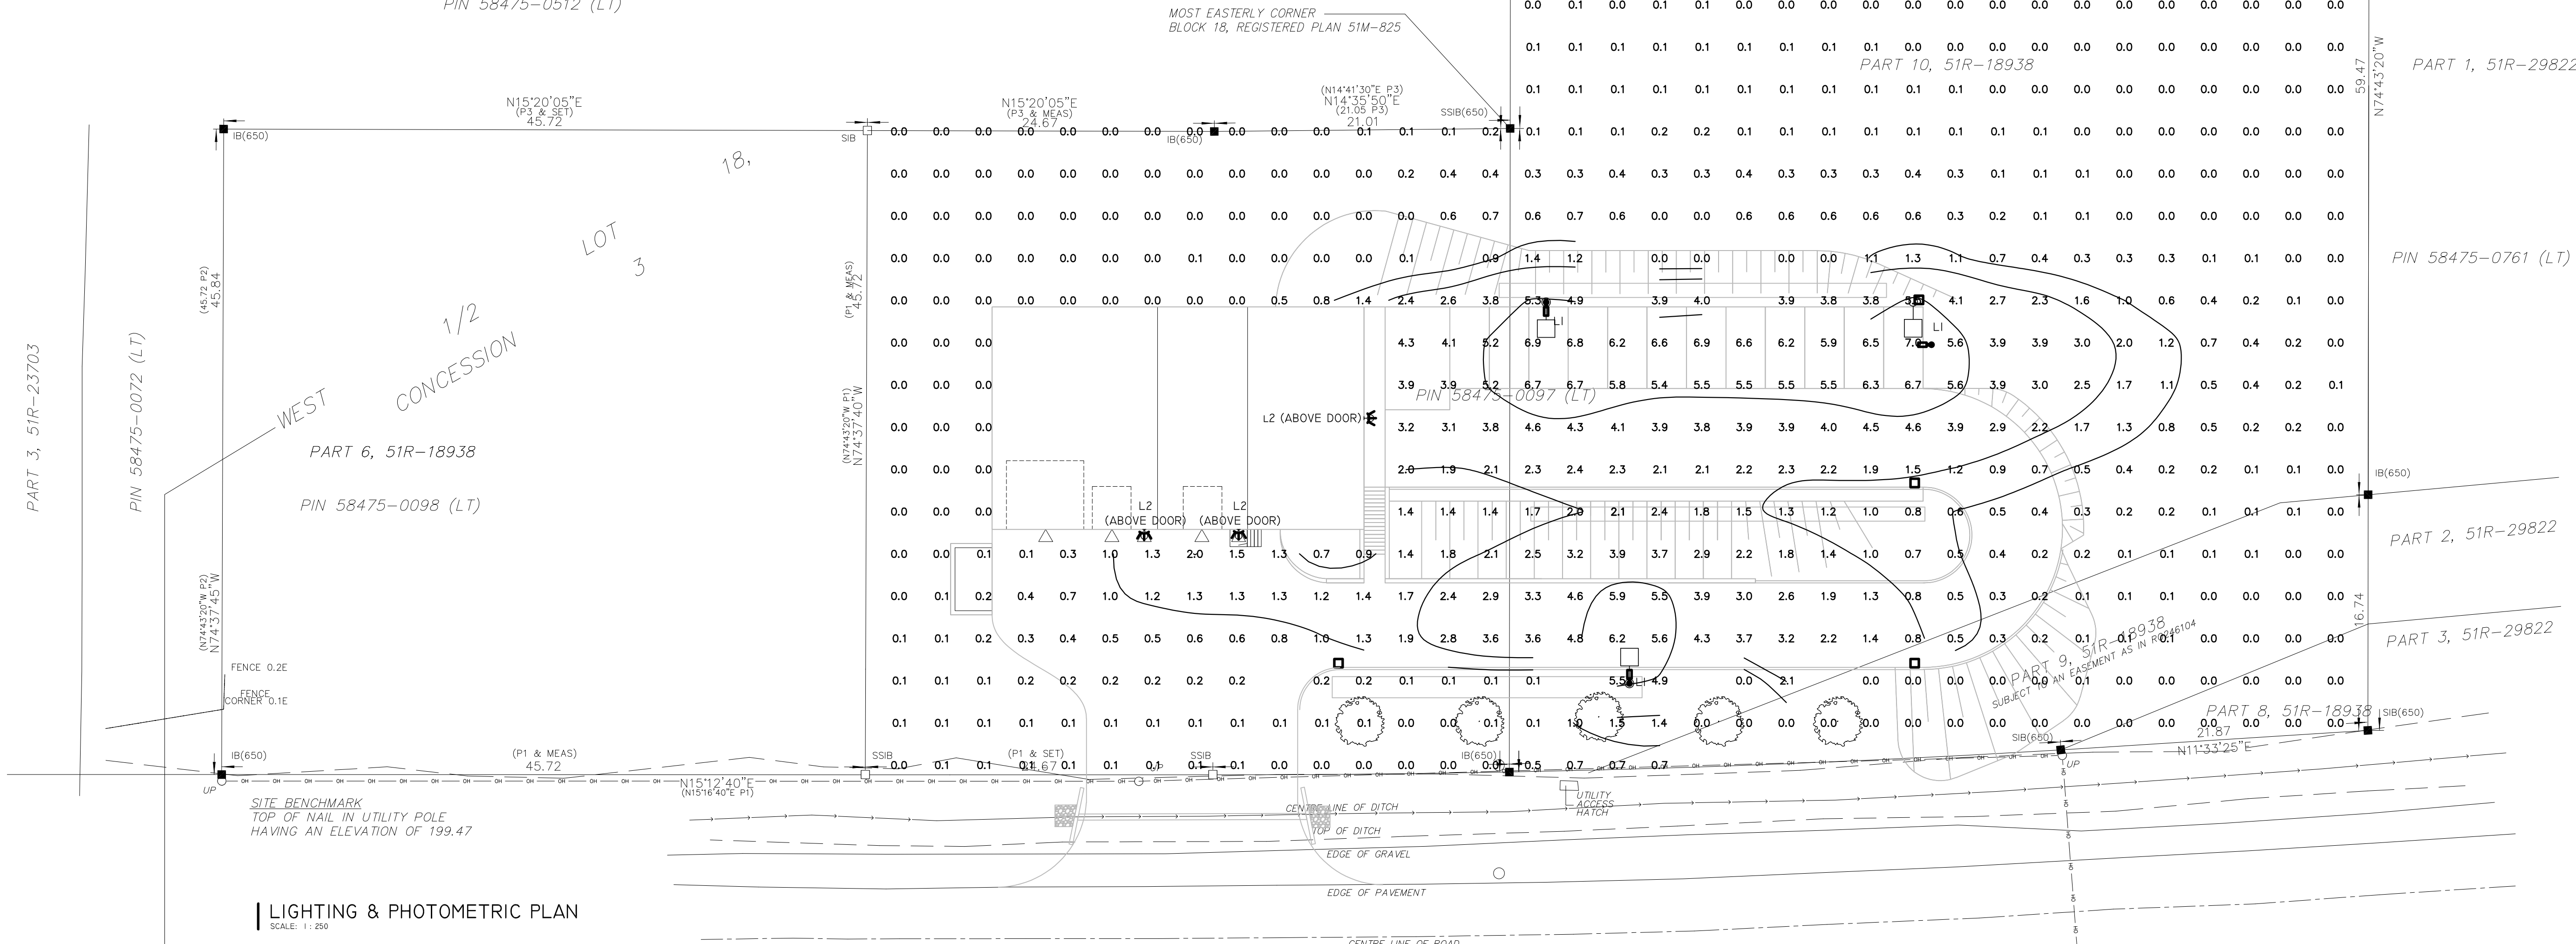

LIGHTING & PHOTOMETRIC PLAN
 SCALE: 1:200

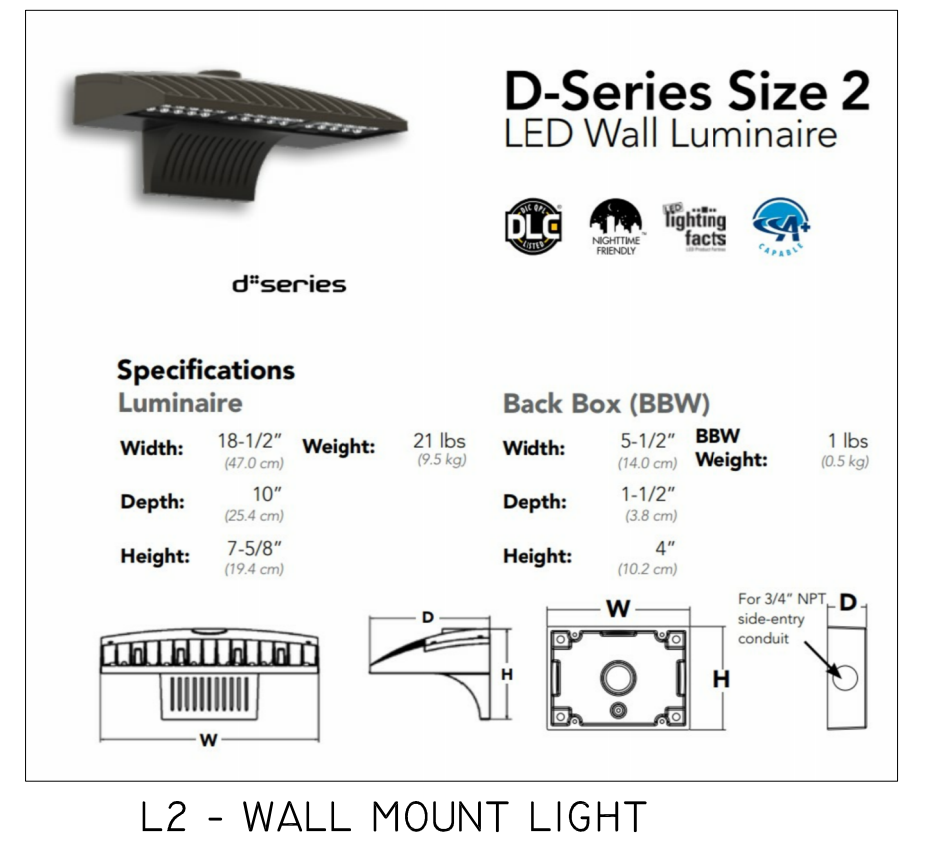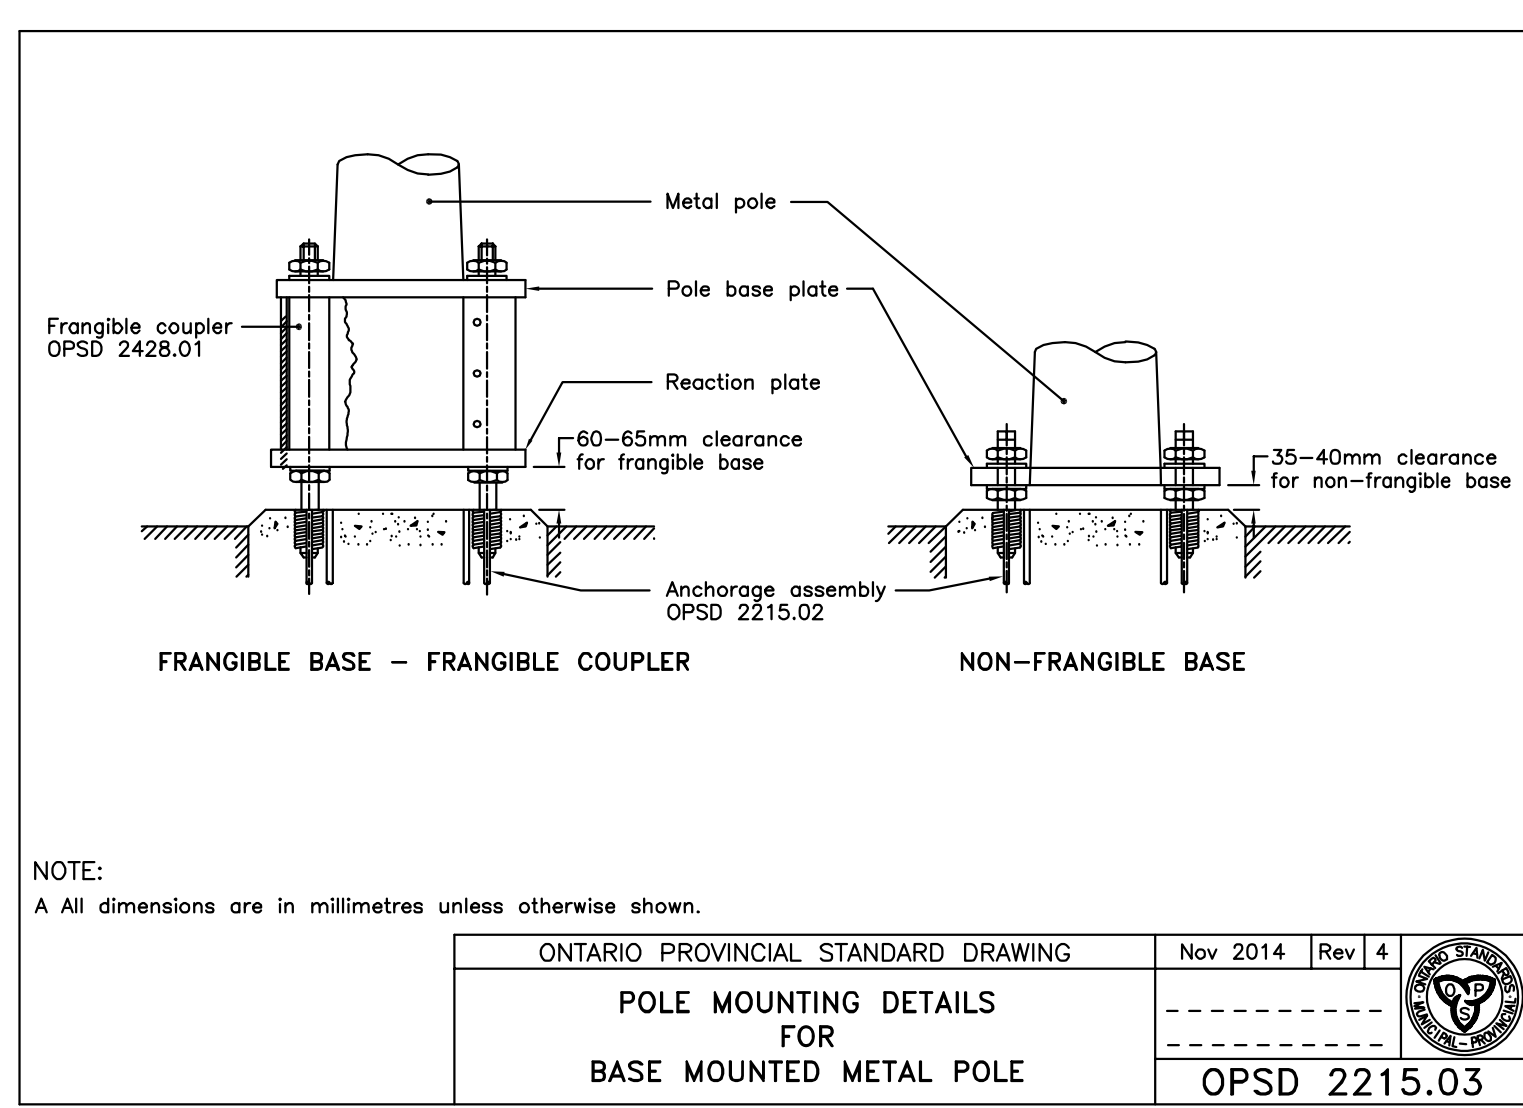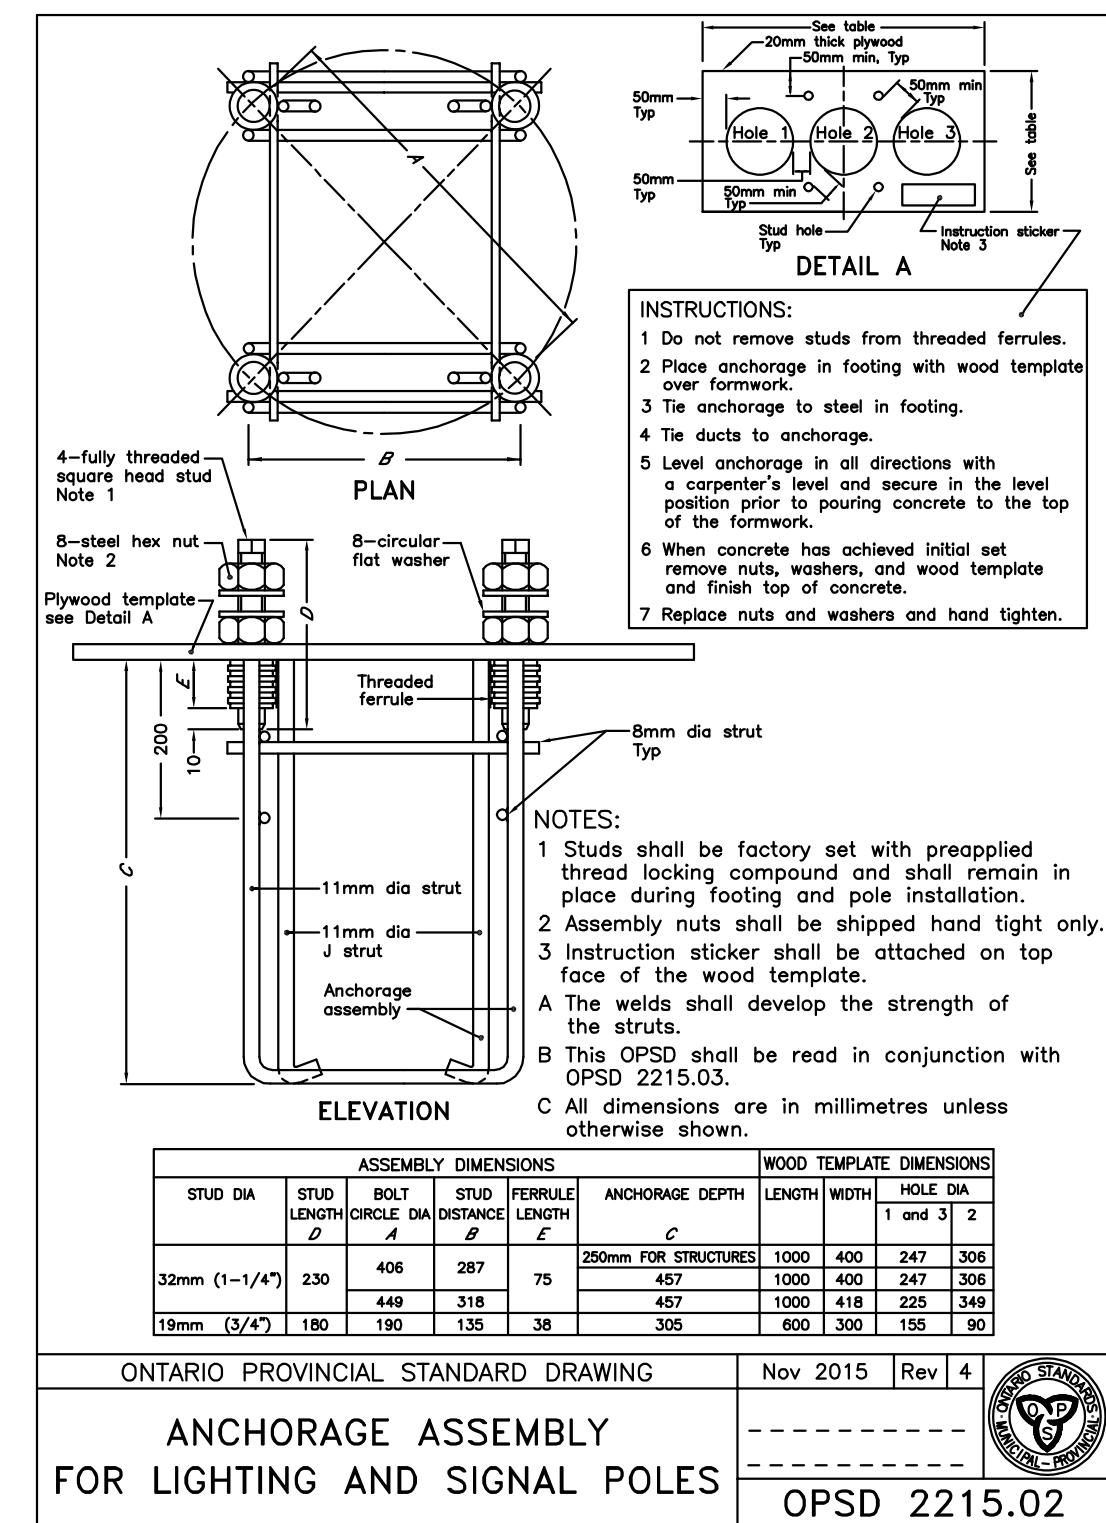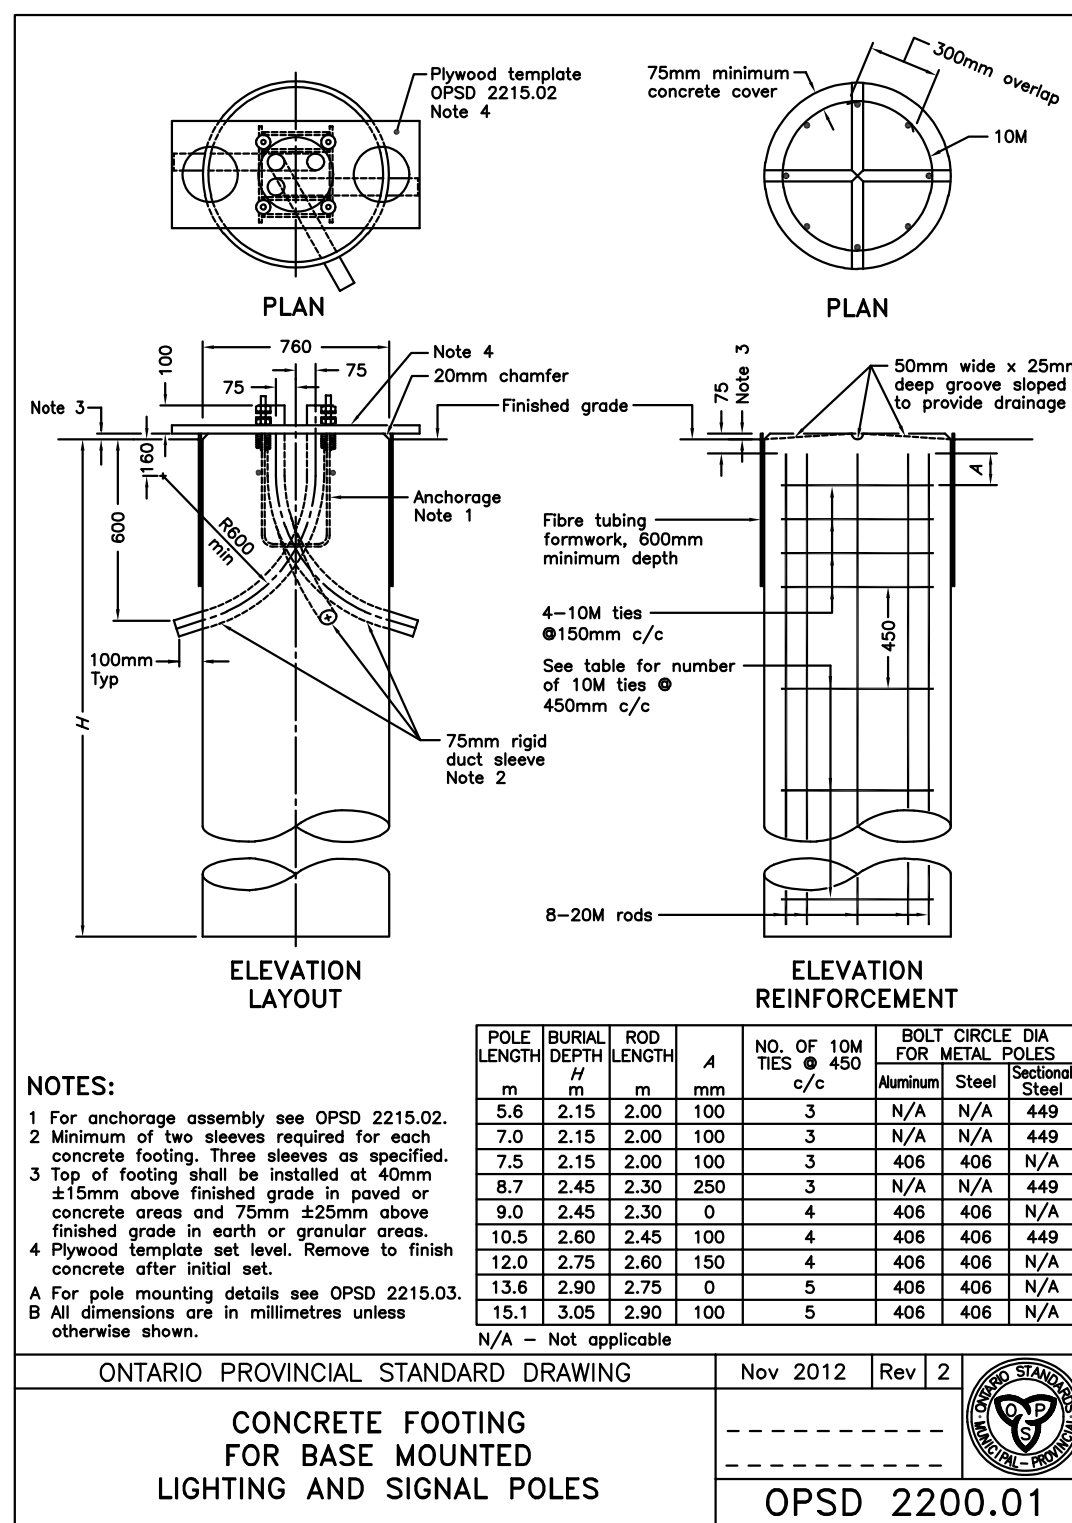

No.	DESCRIPTION	DATE
1		
2		
3		
4		
5		
6	FIRST SUBMISSION	DEC 22, 2023
11	SITE PLAN SUBMISSION	SEPT 25, 2024

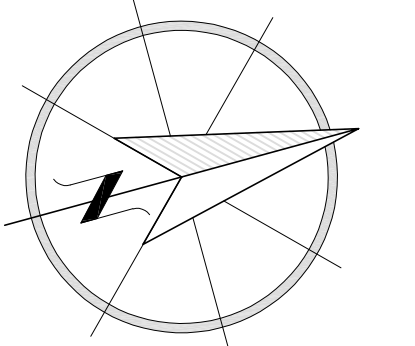

QUANTUM ENGINEERING
 97 CLEVELAND GREEN DR
 TAY, ONTARIO L9M 0H2
 Phone: (705) 549-1791
 Fax: (866) 516-9827
 www.qeng.ca

PROJECT: NEW COMMERCIAL FACILITY
 LOCATION: 120 PILLSBURY DR, MIDLAND, ONTARIO
 FOR: SCHULTZ - VANT SPYKER
 DRAWING: LIGHTING PLAN
 DATE: DEC. 2023 PROJECT NO: 6506 PAGE ID: C5
 SCALE: SEE PLOT